
UNIVERSITY OF SOUTH CAROLINA

CONTROLLERS SUITE RENOVATIONS

1600 HAMPTON STREET-SIXTH FLOOR, COLUMBIA, SC 29201

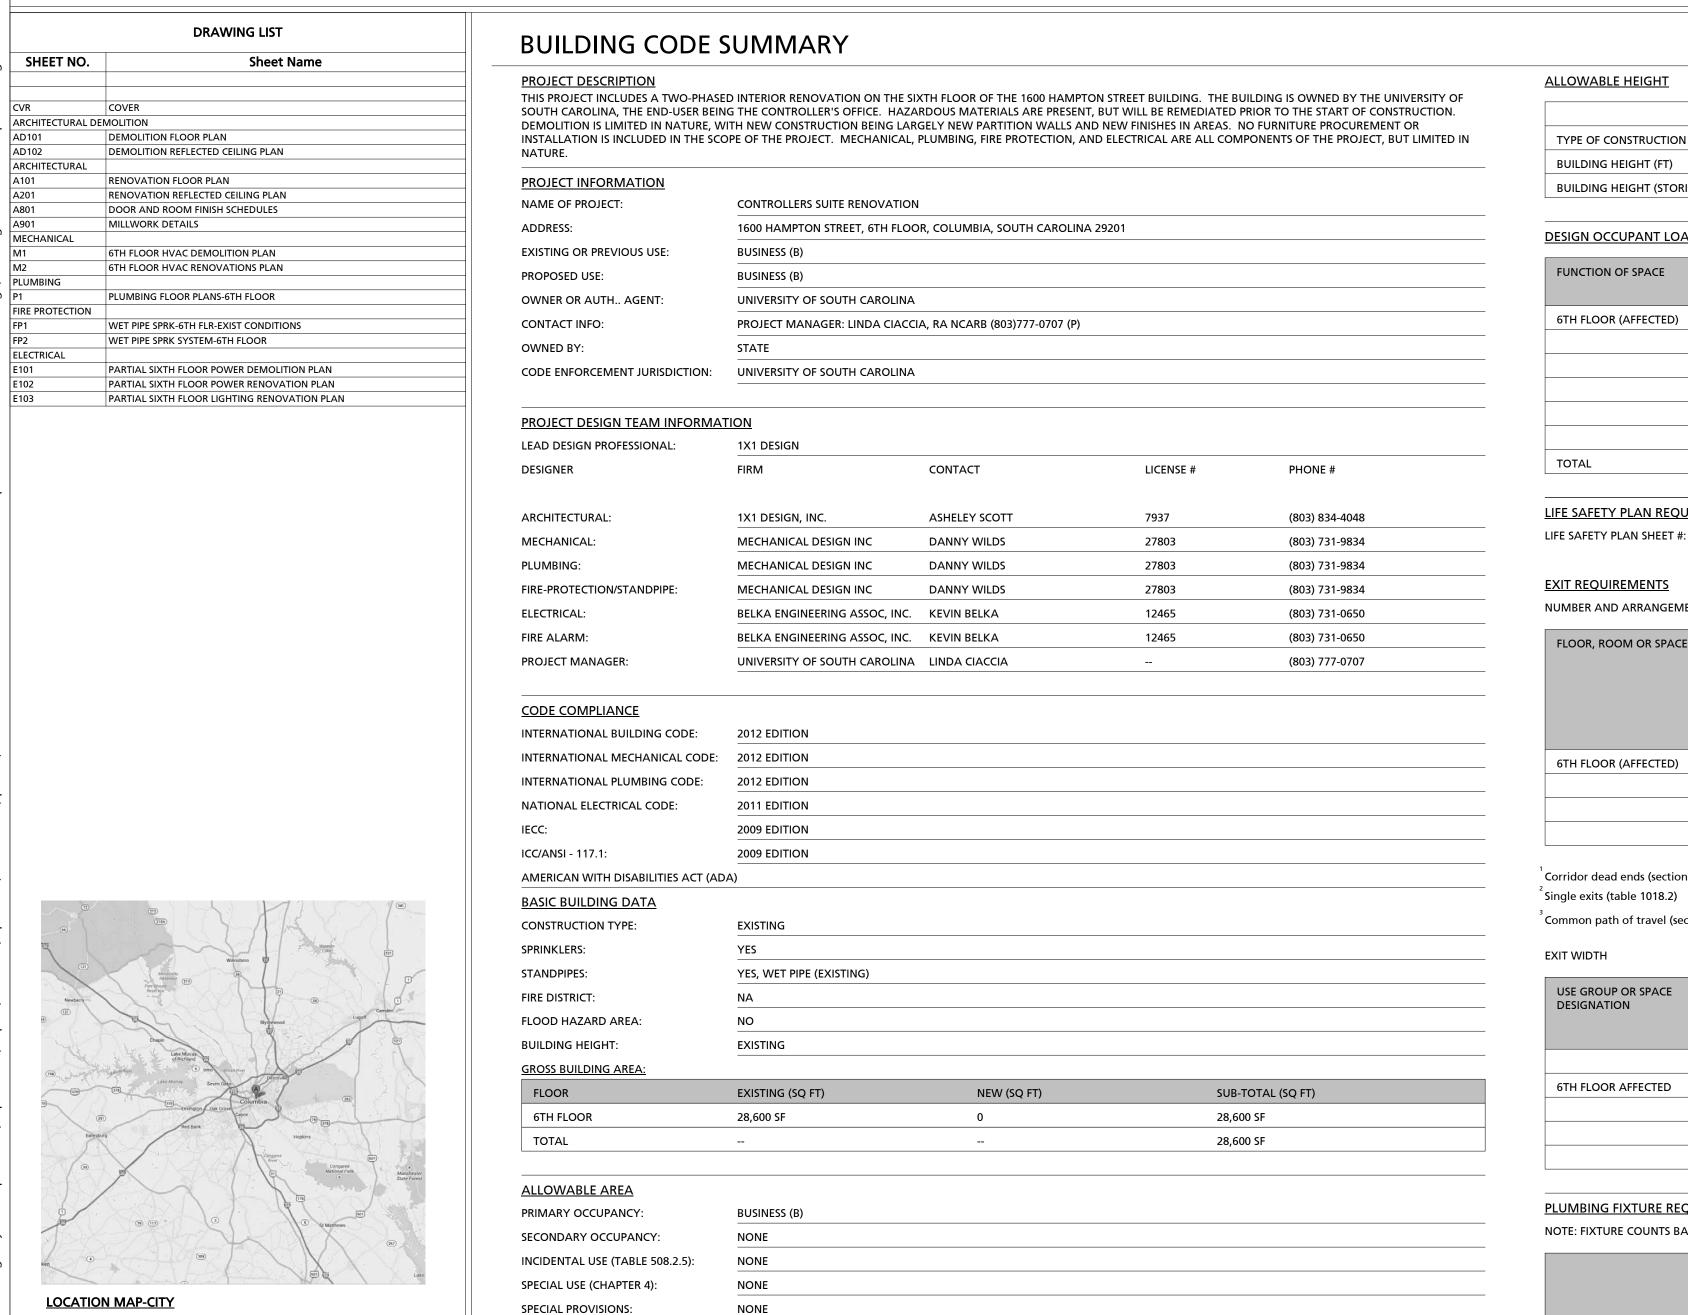

- EXIT ACCESS TRAVEL DISTANCE=122'-0" (EXISTING, UNCHANGED)

SEPARATION: NA

EXCEPTION: --

GROSS SIXTH FLOOR: 28,600 SF TOTAL BUSINESS OCCUPANCY

GROSS AFFECTED AREA: 13,930 SF

BUSINESS OCCUPANCY

ACTUAL EXIT SEPARATION==56'-7" (EXISTING, UNCHANGED)

REQUIRED EXIT SEPARATION= 1/3 OF 244'=81'-4"

EXIT ACCESS TRAVEL DISTANCE=77'-2" (EXISTING,

SIXTH FLOOR-LIFE SAFETY PLAN

MIXED OCCUPANCY:

INCIDENTAL USE SEPARATION (508.2.5): NA



LOCATION MAP-LOCAL

	ALLOWABLE (TABLE 503)	INCREASE FOR SPRINKLERS	SHOWN ON PLANS	CODE REFERENCE
TYPE OF CONSTRUCTION	TYPE: II-B, EXI	STING ASSUMED	EXISTING	
BUILDING HEIGHT (FT)	EXISTING	FEET= H + 20'= <u></u>	NA	
BUILDING HEIGHT (STORIES)	EXISTING	STORIES + 1=	8	

FLOOR AREA IN SO ET PER OCCUPANT

DESIGN OCCUPANT LOAD (TABLE 1004.1)

TONCHON OF STACE	TEOOR AREA IN SQ TTTER OCCUPANT	ANEA LEIVI EARS	TOTAL OCCUPANTS FER TONCHON
6TH FLOOR (AFFECTED)	100 SF/OCCUPANT	13,930 SF	139.3 OCC
TOTAL			139.3 OCC=140 OCC

TOTAL OCCUPANTS PER FUNCTION

LIFE SAFETY PLAN REQUIREMENTS

EXIT REQUIREMENTS

NUMBER AND ARRANGEMENT OF EXITS

FLOOR, ROOM OR SPACE	MINIMUM NUMBER O	PF EXITS ²	TRAVEL DISTANCE ARRANGEMENTS ME (SECTION 1015.2) 1,3			NS OF EGRESS
	REQ'D	SHOWN ON PLANS	ALLOWABLE TRAVEL DISTANCE (TABLE 1016.2)	ACTUAL TRAVEL DISTANCE SHOWN ON PLANS	REQUIRED DISTANCE BETWEEN EXIT DOORS	ACTUAL DISTANCE SHOWN ON PLANS
6TH FLOOR (AFFECTED)	2	2	300'	<300'	81'-4"	56'-7" EXISTING

Corridor dead ends (section 1016.3)


Common path of travel (section 1013.3)

USE GROUP OR SPACE DESIGNATION	OCCUPANT LOAD BASED ON 1004.1	EGRESS WIDTH PER OCCUPANT (SEC 1005.3)	REQUIRED WIDTH		ACTUAL EXIT WIDTH SHOWN ON PLANS	
			STAIRS	OTHER ELEMENTS	STAIRS	OTHER ELEMENTS
6TH FLOOR AFFECTED	140	.2"/.15"	28"	21"	126"	64"

PLUMBING FIXTURE REQUIREMENTS (TABLE 2902.1)

NOTE: FIXTURE COUNTS BASED UPON DESIGN OCCUPANT LOAD

	WATER CLOSETS		URINALS	LAVATORIES		SHOWERS/ TUBS	DRINKING FOUNTAINS	
	MALE:	FEMALE:		MALE:	FEMALE:		REGULAR:	ANSI/ADA:
REQUIRED:								
6TH FLOOR GROSS (143 M, 143 F)	4	4		3	3		1	1
6TH FLOOR AFFECTED (70 M, 70 F)	3	3		2	2		1	1
PROVIDED:								
6TH FLOOR GROSS (143 M, 143 F)	3	6	3	4	5		1	

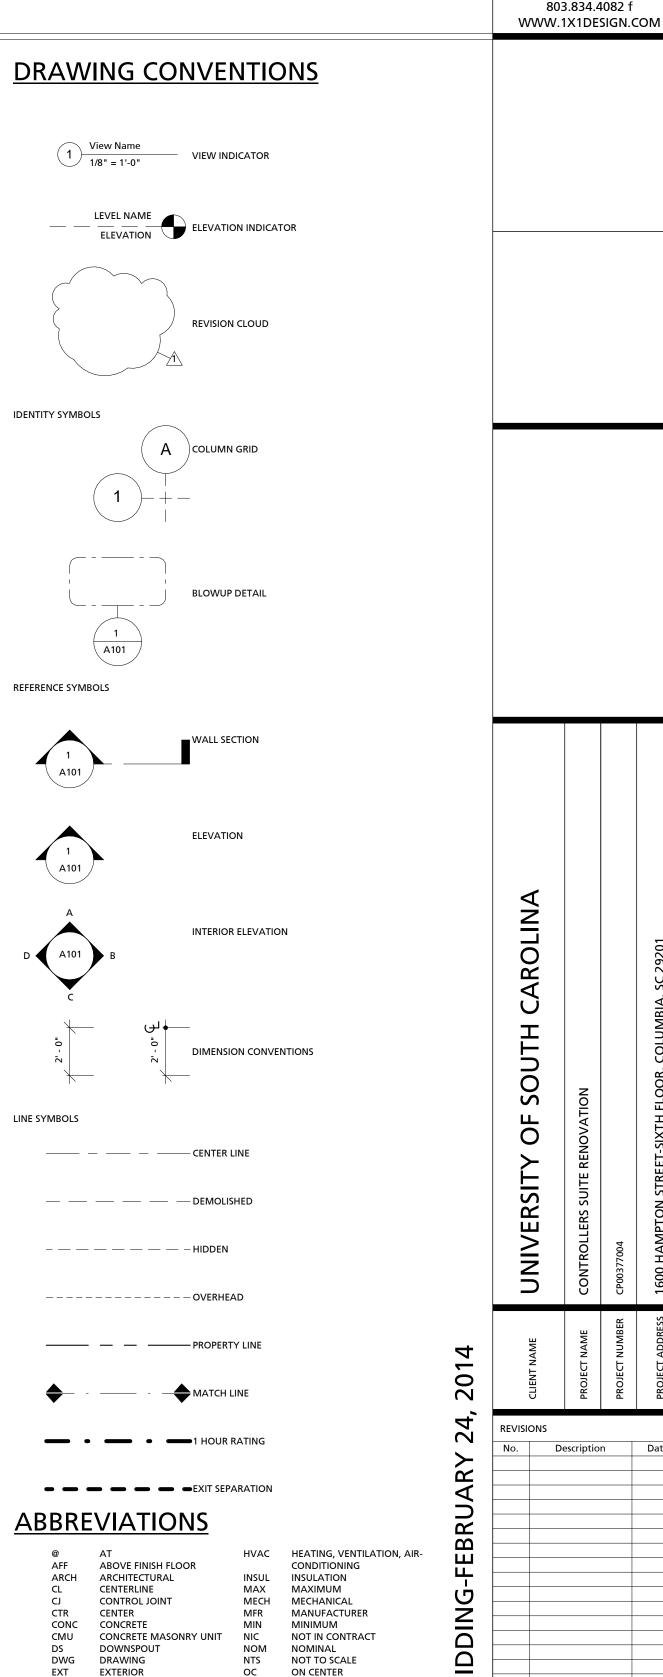

OPPOSITE REQUIRED

TOP OF STEEL

VERIFY IN FIELD

UNLESS NOTED OTHERWISE

COVER

02.24.14

EXIST EXISTING

EQUIP EQUIPMENT

GYP BD GYPSUM BOARD

HM HOLLOW METAL

ELECTRIC WATER COOLER

FIRE EXTINGUISHER CABINET STR

FLOOR DRAIN

COLUMBIA, SOUTH CAROLINA

803.834.4048 p



DEMOLITION TAGS AND NOTES-MAIN ENTRY

REMOVE EXISTING FLOORING, BASE, MASTIC, ADHESIVE, ETC. IN ITS ENTIRETY.
DISPOSE MATERIALS AS REQUIRED. PATCH ALL FLOOR AREAS AS REQUIRED TO PROVIDE LEVEL SURFACE APPROPRIATE FOR NEW FINISHES, AS SPECIFIED.

(2) EXISTING CEILING GRID AND TILES TO REMAIN

(3) EXISTING CABINET TO BE REMOVED AND MODIFIED FOR REUSE WITHIN EXISTING

4 EXISTING FLOOR TILE TO REMAIN.

(5) REMOVE EXISTING DOOR AND FRAME; RETAIN FOR REUSE. REMOVE EXISTING FOREIGN DEBRIS, PATCH DOORS TO APPEAR "LIKE NEW". PREP TO RECEIVE NEW FINISH, AS INDICATED.

(6) REMOVE EXISTING CHAIR RAIL. PREPARE WALL TO RECEIVE NEW FINISH, AS

8 REMOVE EXISTING WALL IN ITS ENTIRETY. REMOVE ALL POWER, DATA, FIRE, ALARM, SECURITY, TELEPHONE, ETC. LOCATED IN WALL.

DEMOLITION LEGEND-SEE NOTES FOR MORE DETAILS

EXISTING WALL TO BE REMOVED

EXISTING DOOR TO BE REMOVED

GENERAL DEMOLITION NOTES

A. ROOM NUMBERS SHOWN ON DEMOLITION PLANS REFER TO EXISTING ROOMS

B. CLEANING OF THE SUBSTRATES, SUBSTRATE SURFACE PREPARATION, AND INSTALLATION FOR ALL NEW FINISH MATERIALS TO BE IN ACCORDANCE WITH MANUFACTURER'S PRINTED RECOMMENDATIONS.

C. EXISTING FURNITURE REMOVAL TO BE COORDINATED BY END-USER. EXISTING DESKS TO BE COVERED TO PROTECT FROM DUST DURING CONSTRUCTION

E. ROOM SIGN INSTALLATION AND/OR MODIFICATIONS TO BE COORDINATED BY PROJECT MANAGER.

F. EXISTING CONDITIONS AND DEMOLITION NOTES BASED ON INFORMATION PROVIDED BY OWNER AND/OR INFORMATION GATHERED DURING GENERAL FIELD OBSERVATION. IF GC DISCOVERS EXISTING CONDITIONS DIFFER FROM THOSE SHOWN, CONTACT PROJECT MANAGER IMMEDIATELY.

G. GENERAL CONTRACTOR TO FIELD VERIFY CONDITIONS PRIOR TO START OF

H. SECURE ALL INTERIOR BLINDS DURING CONSTRUCTION FOR REUSE. INVENTORY ANY DAMAGED BLINDS, AND REPORT TO PROJECT MANAGER.

1600 HAMPTON STREET-SIXTH FLOOR KEY PLAN



221 PICKENS STREET (29205) POST OFFICE BOX 5875 COLUMBIA, SOUTH CAROLINA 29250 803.834.4048 p 803.834.4082 f WWW.1X1DESIGN.COM


SOUTH OF UNIVERSITY

2014

BIDDING-FEBRUARY

AD101 SHEET NAME
DEMOLITION FLOOR PLAN


02.24.14

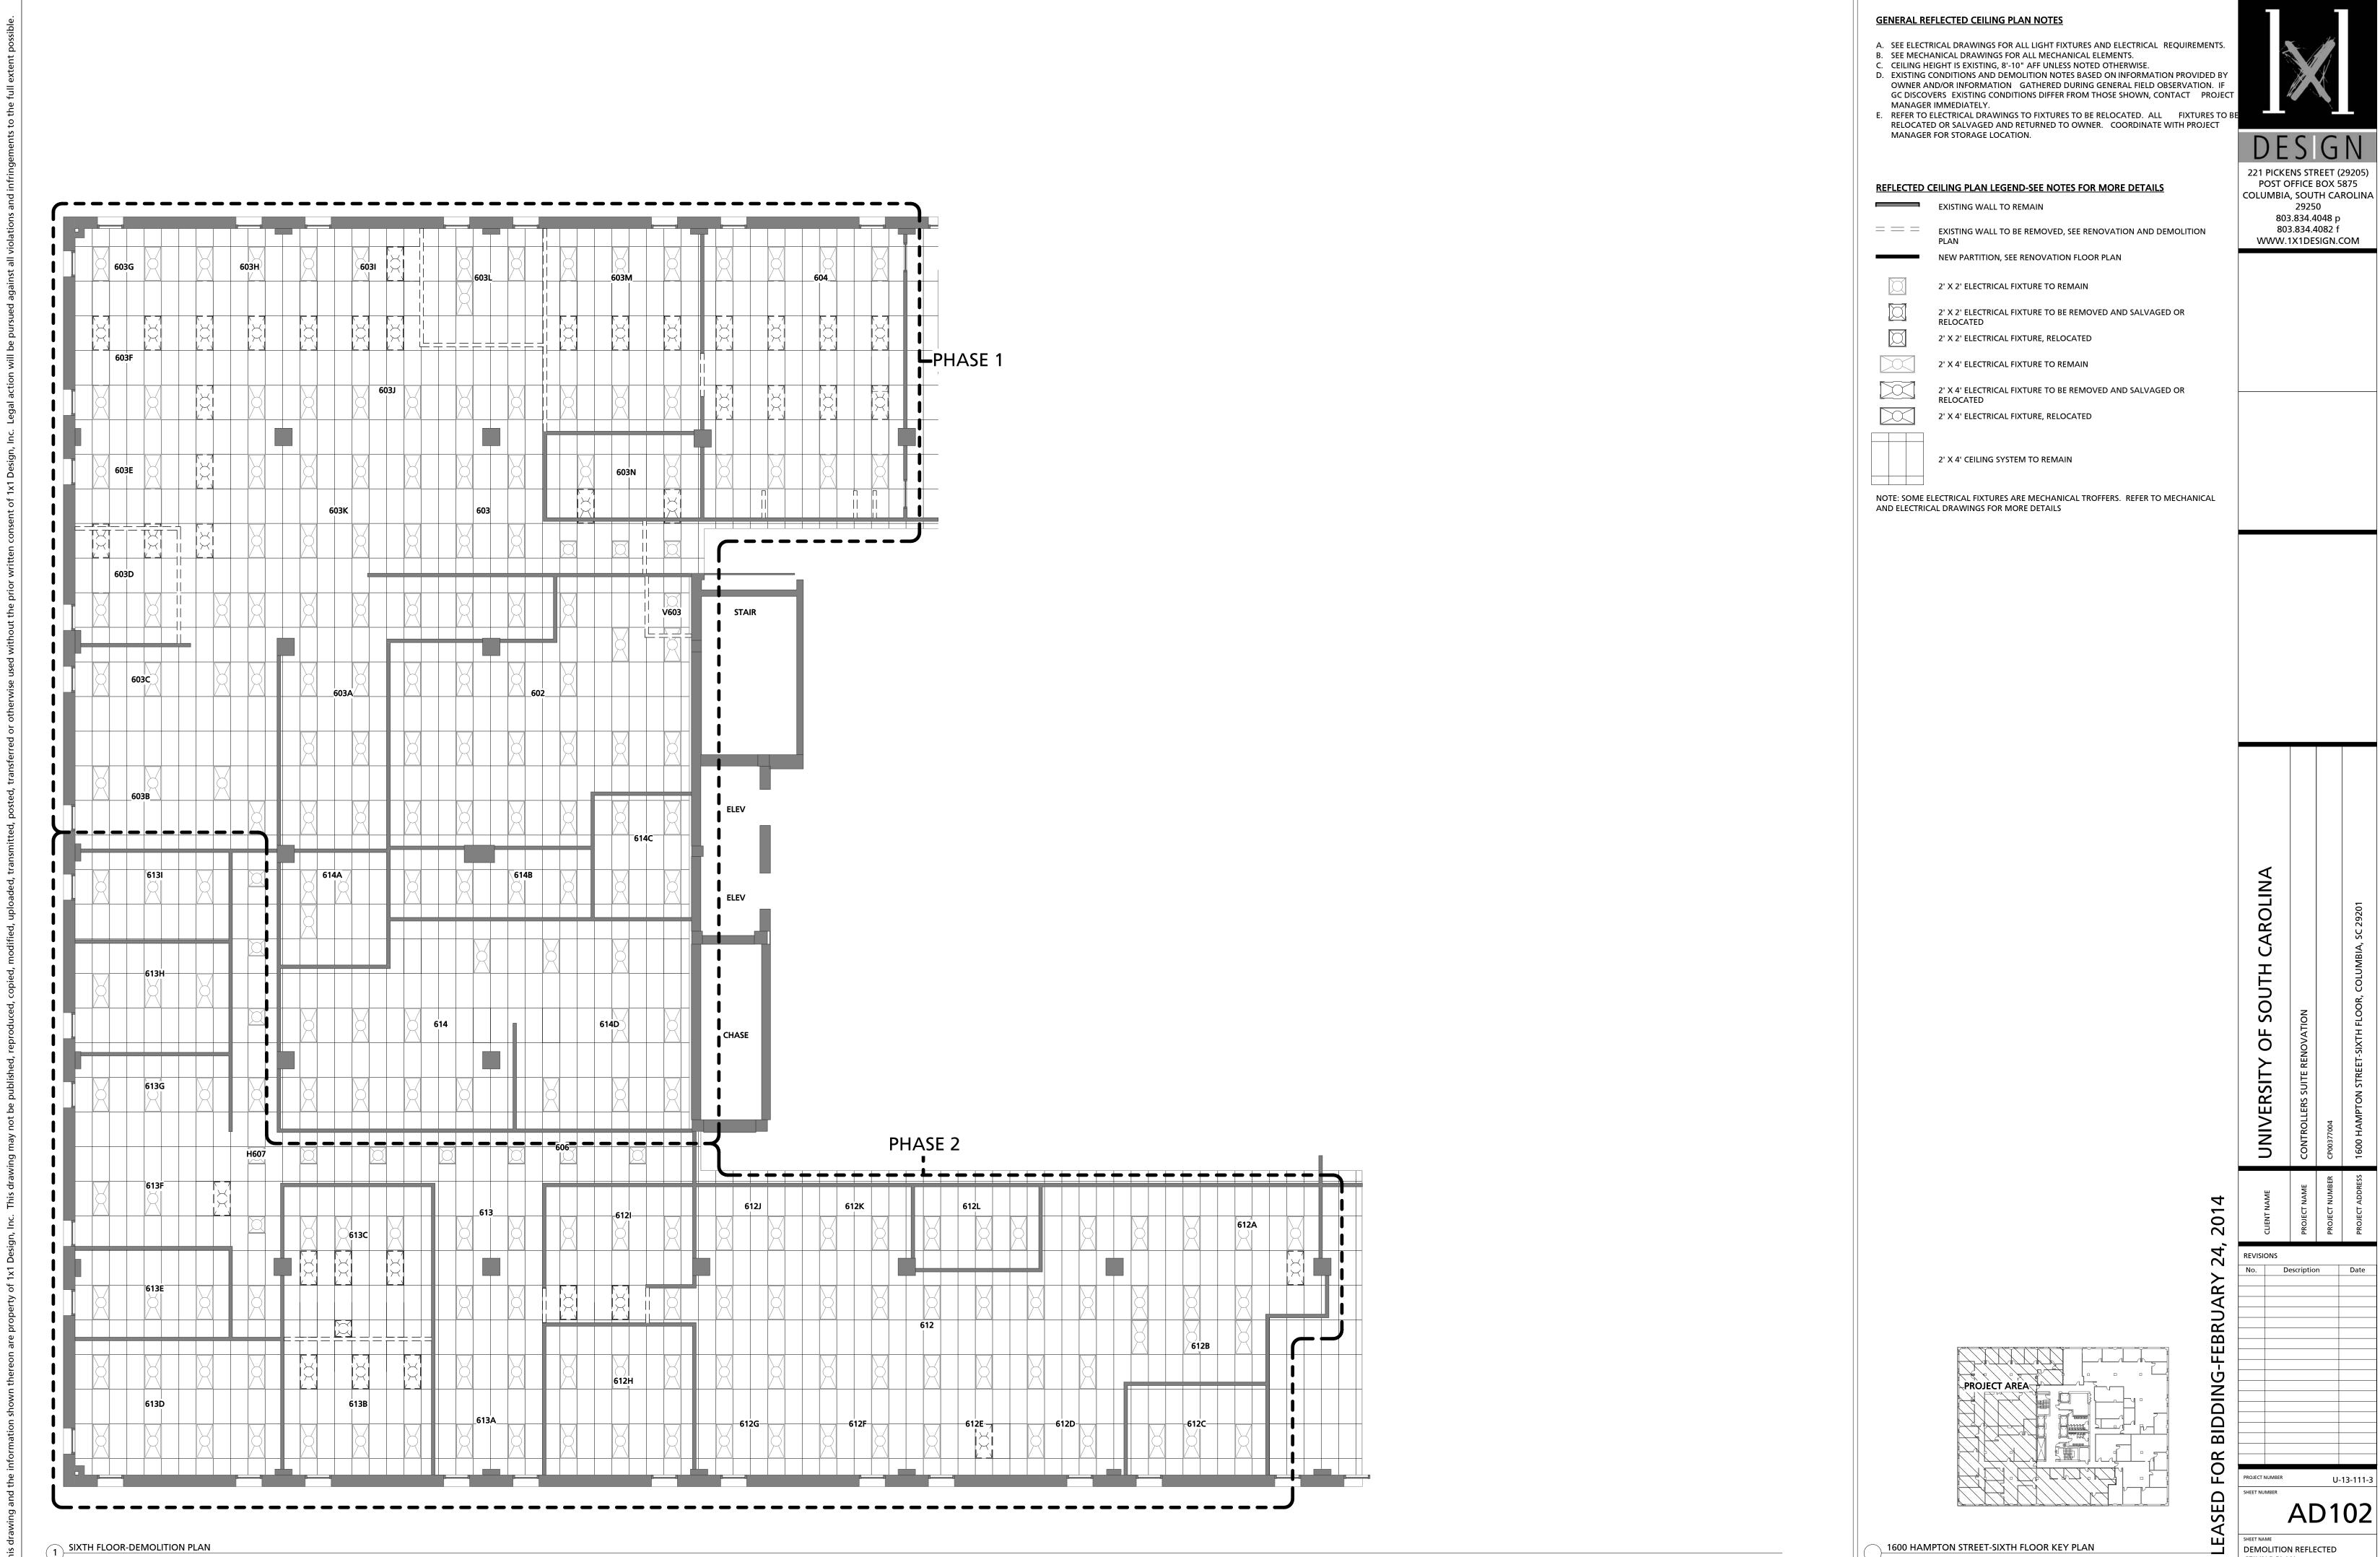

1/8" = 1'-0"


CEILING PLAN 02.24.14

1/64" = 1'-0"

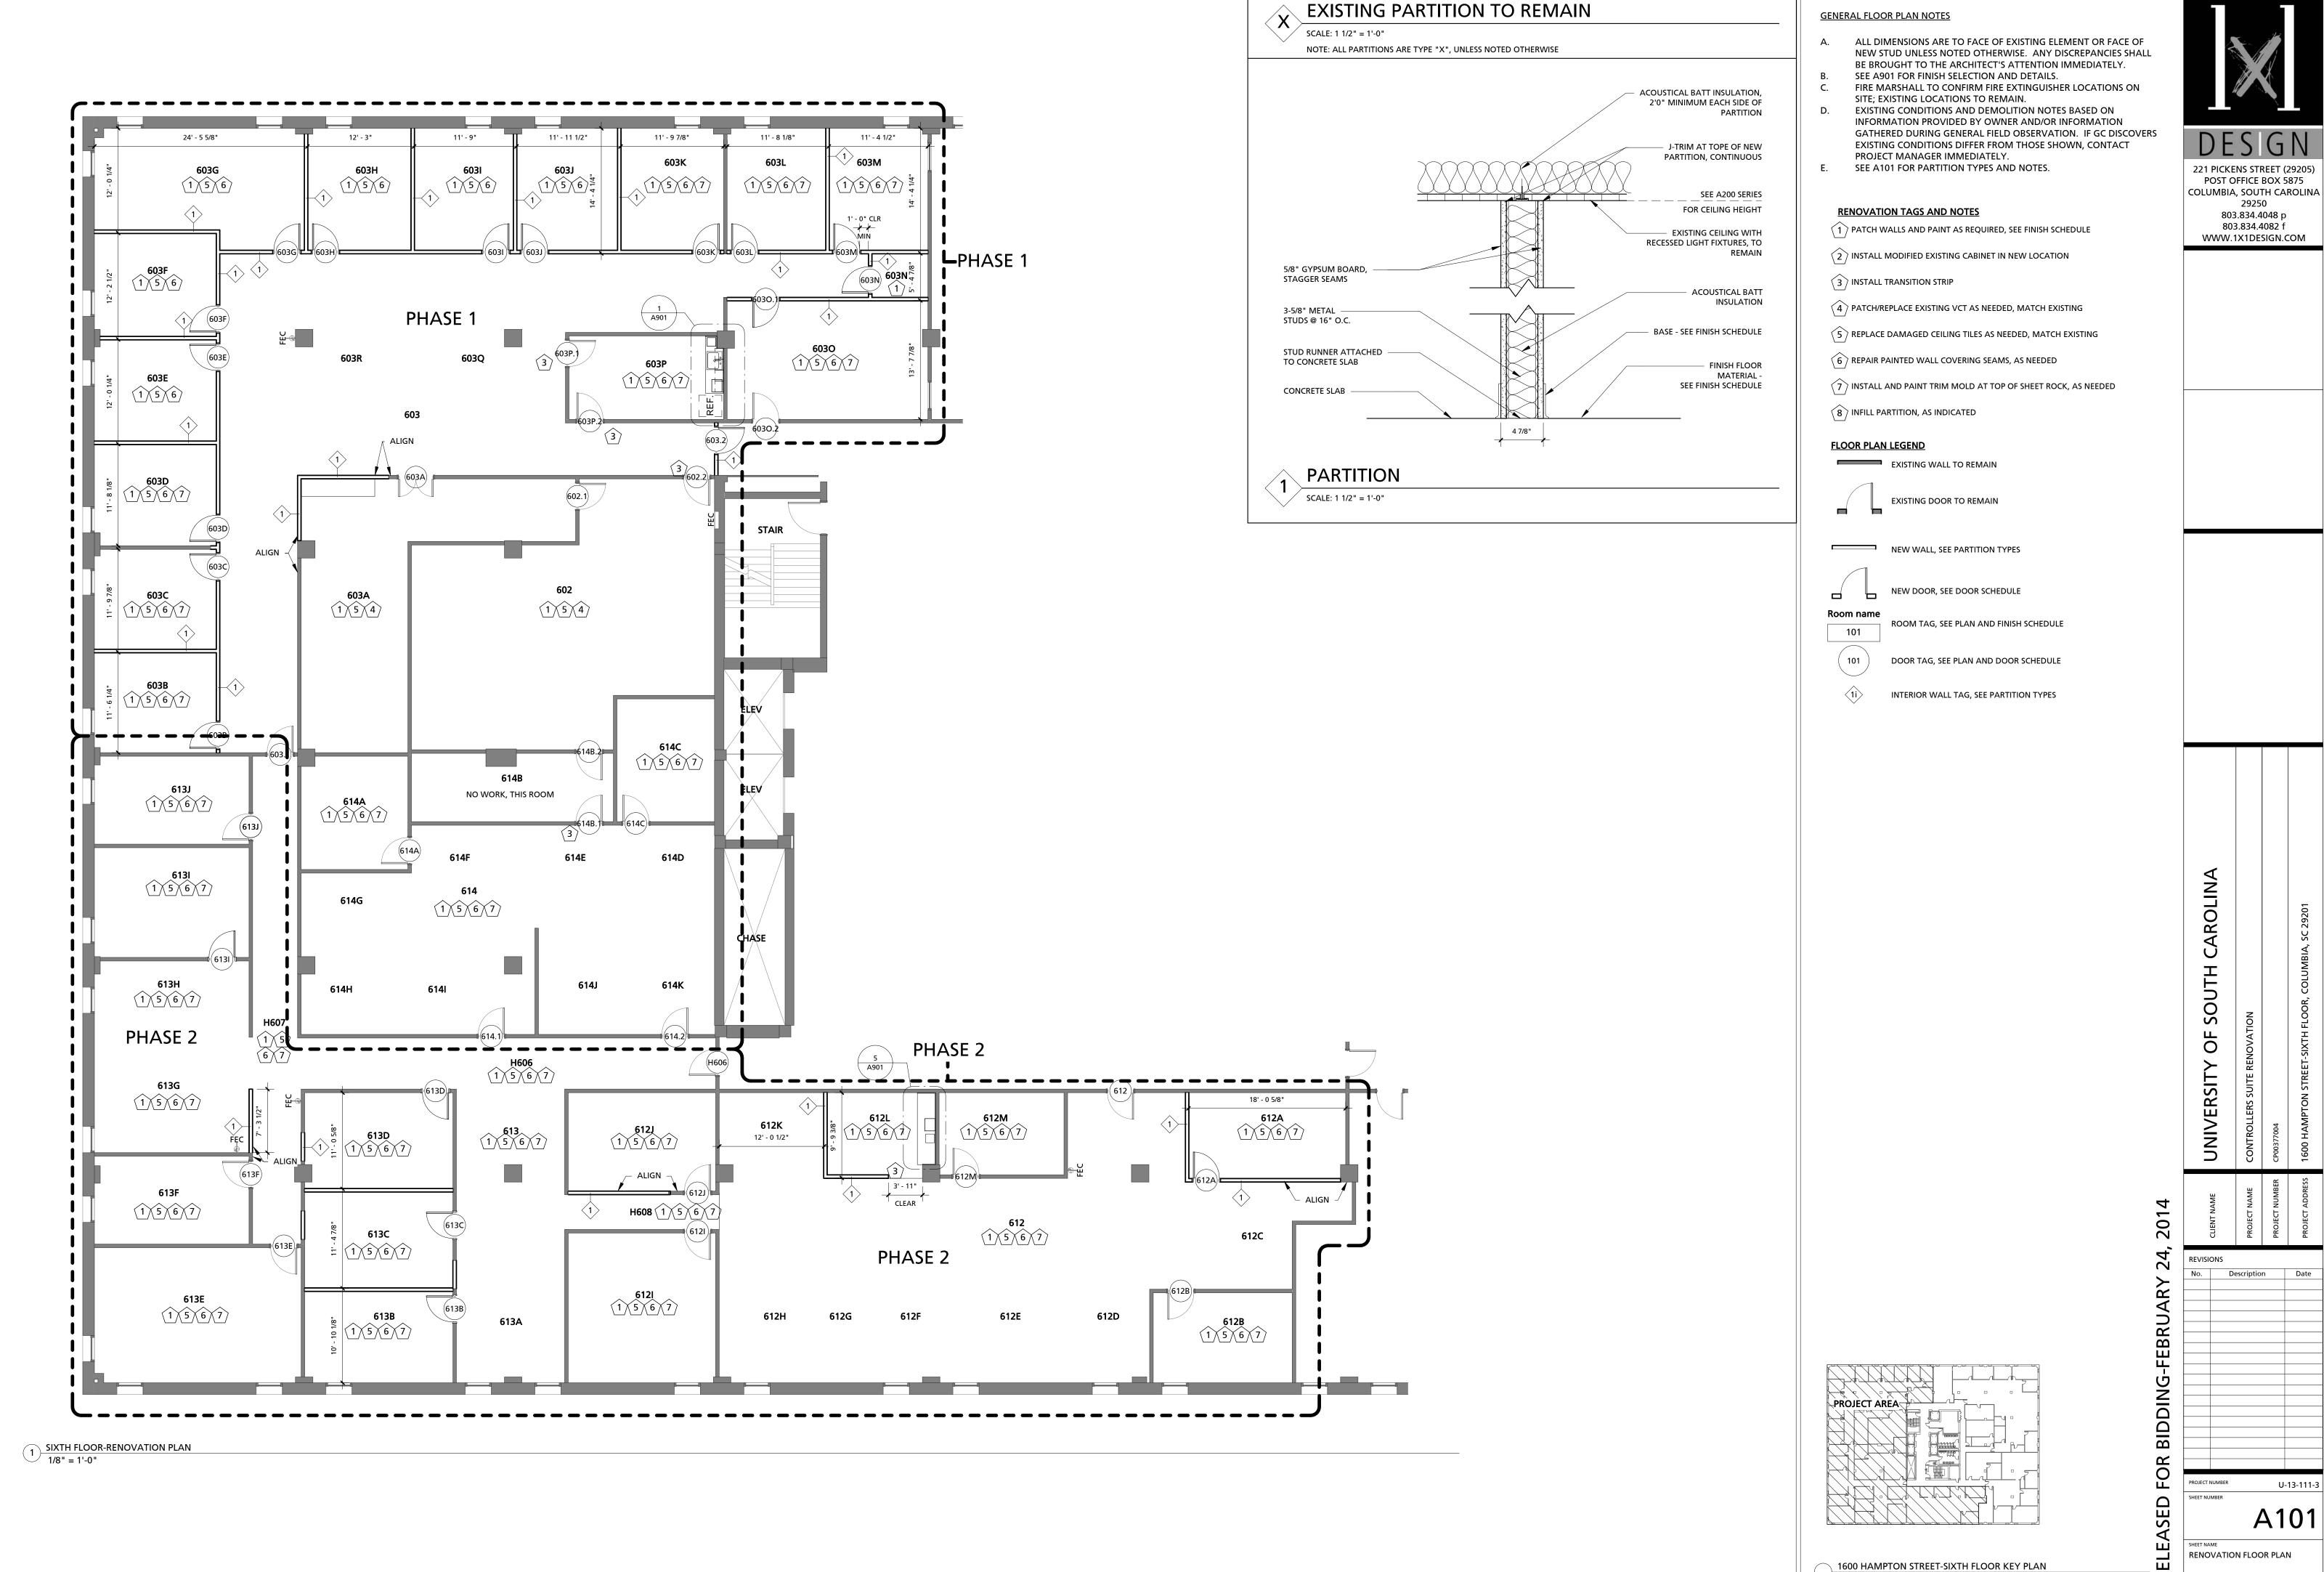


1/64" = 1'-0"

02.24.14

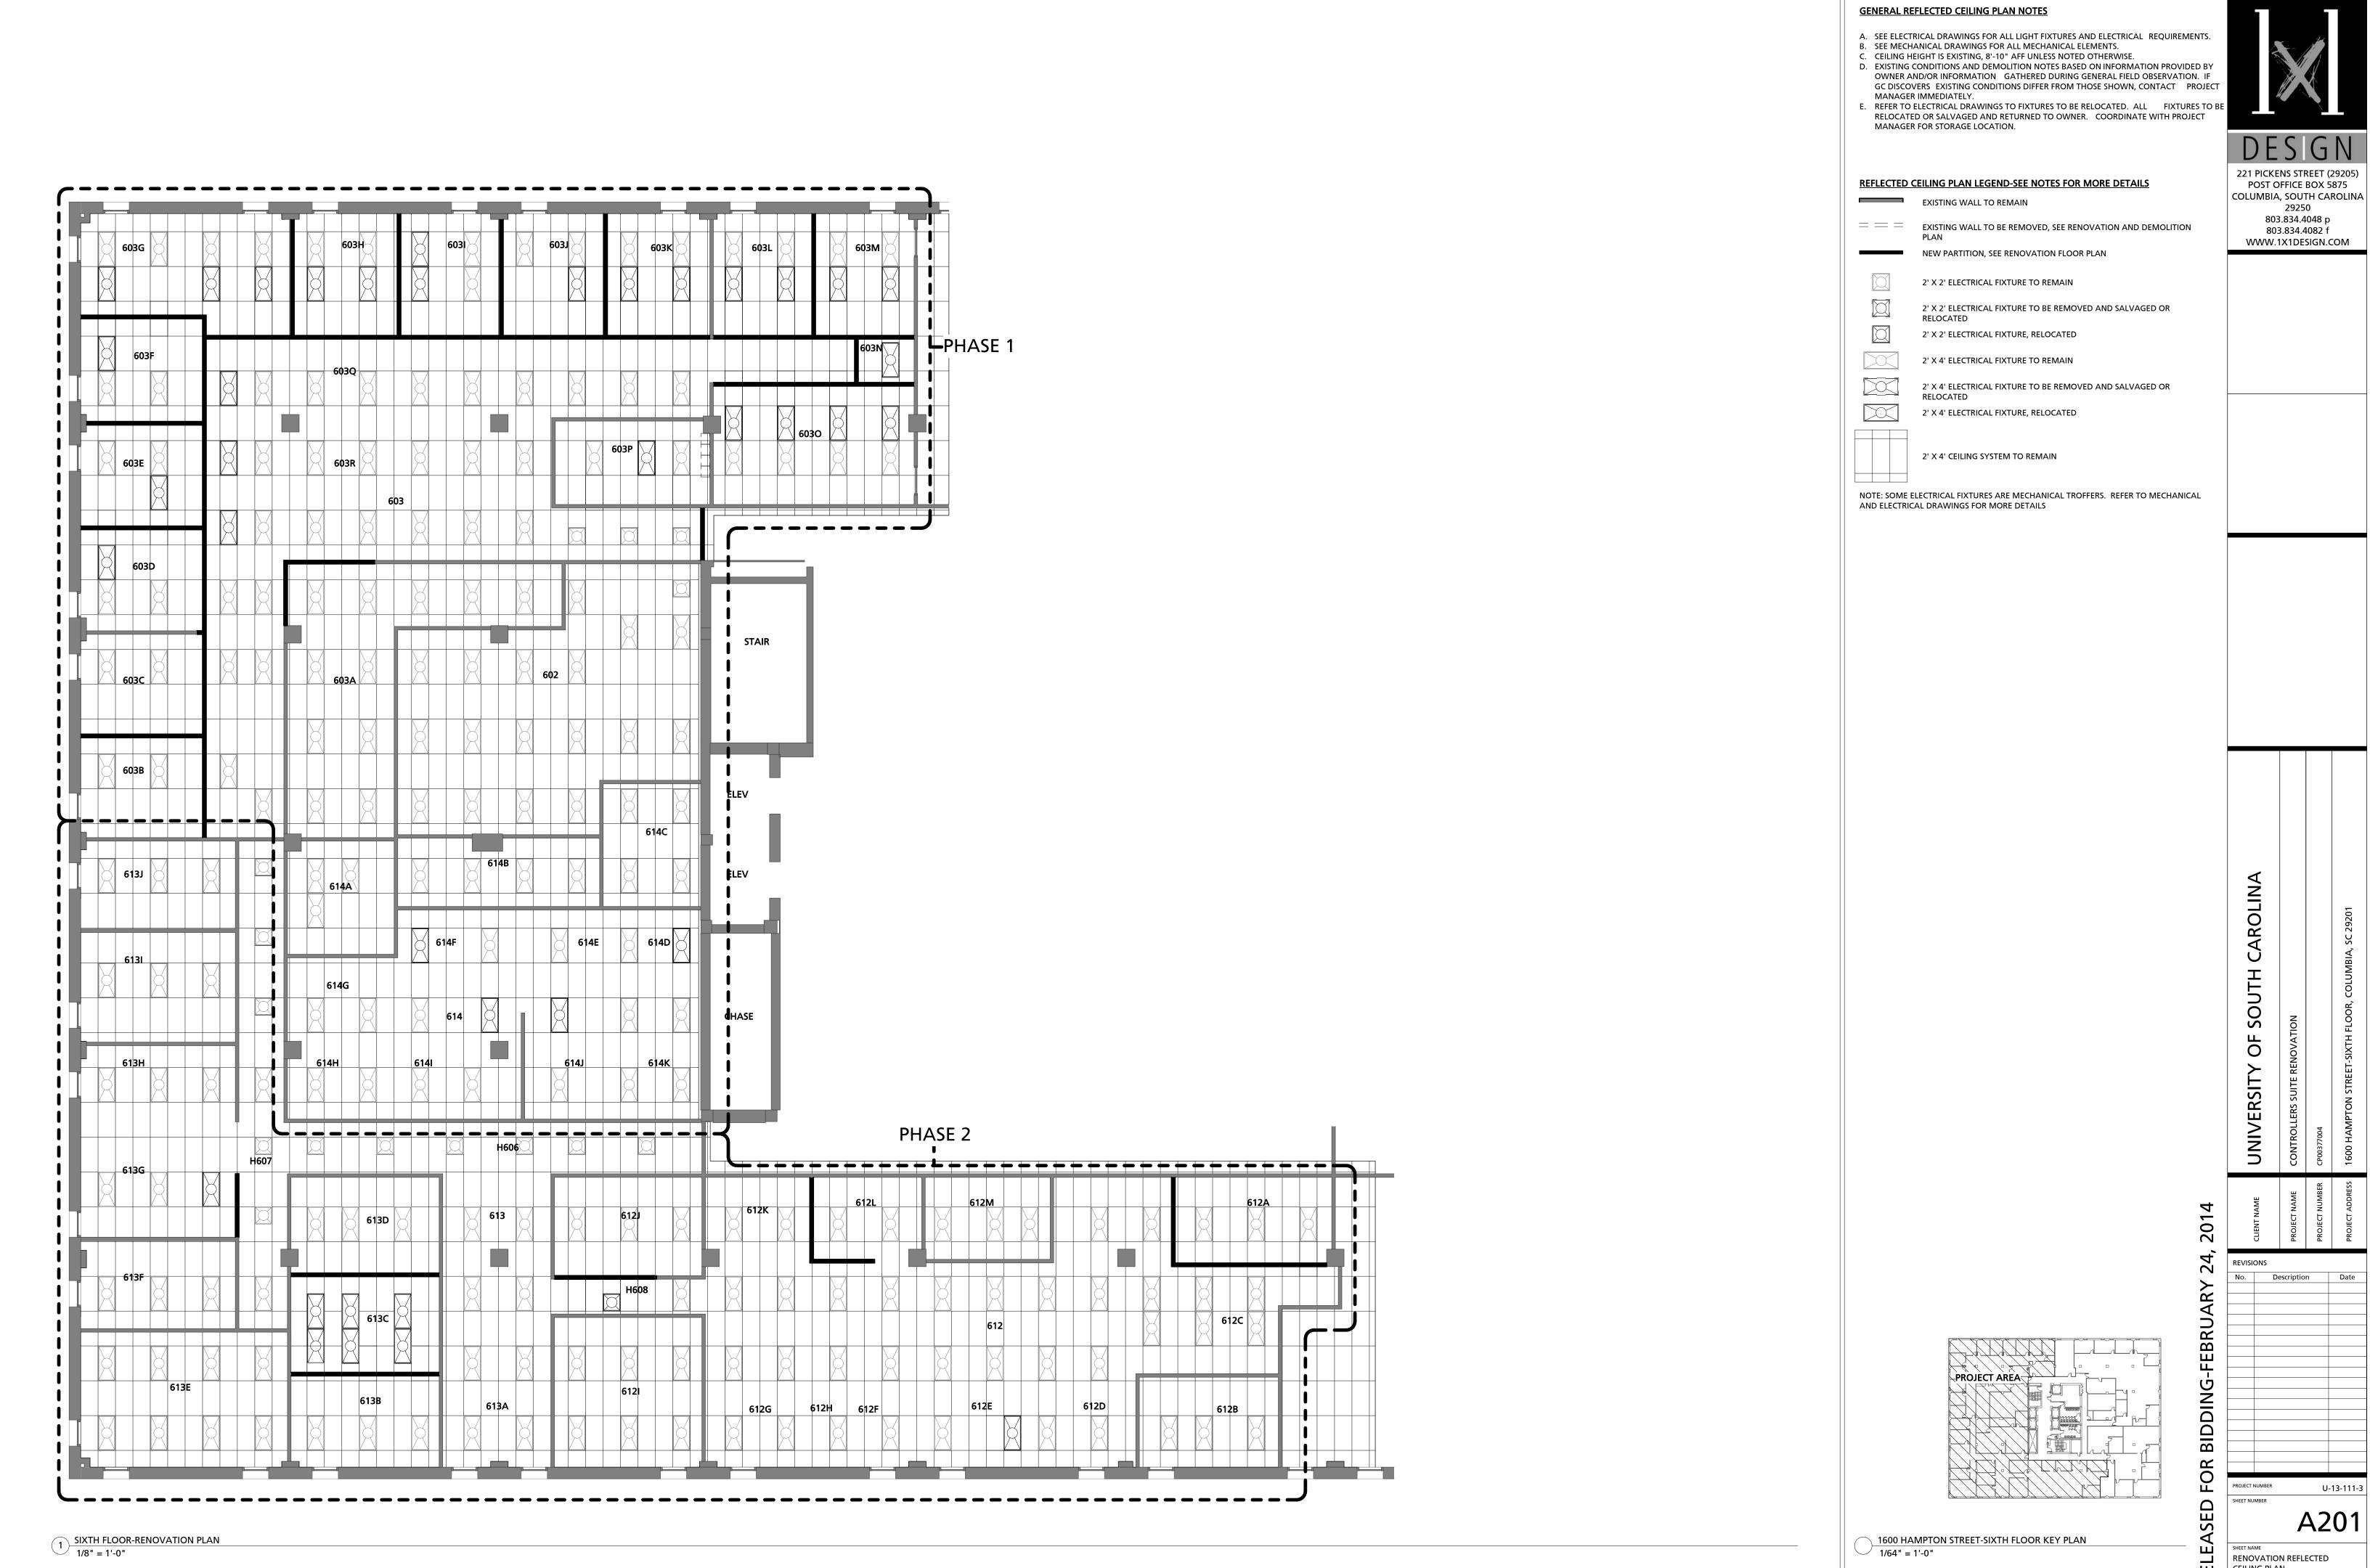

U-13-111-3

CEILING PLAN 02.24.14

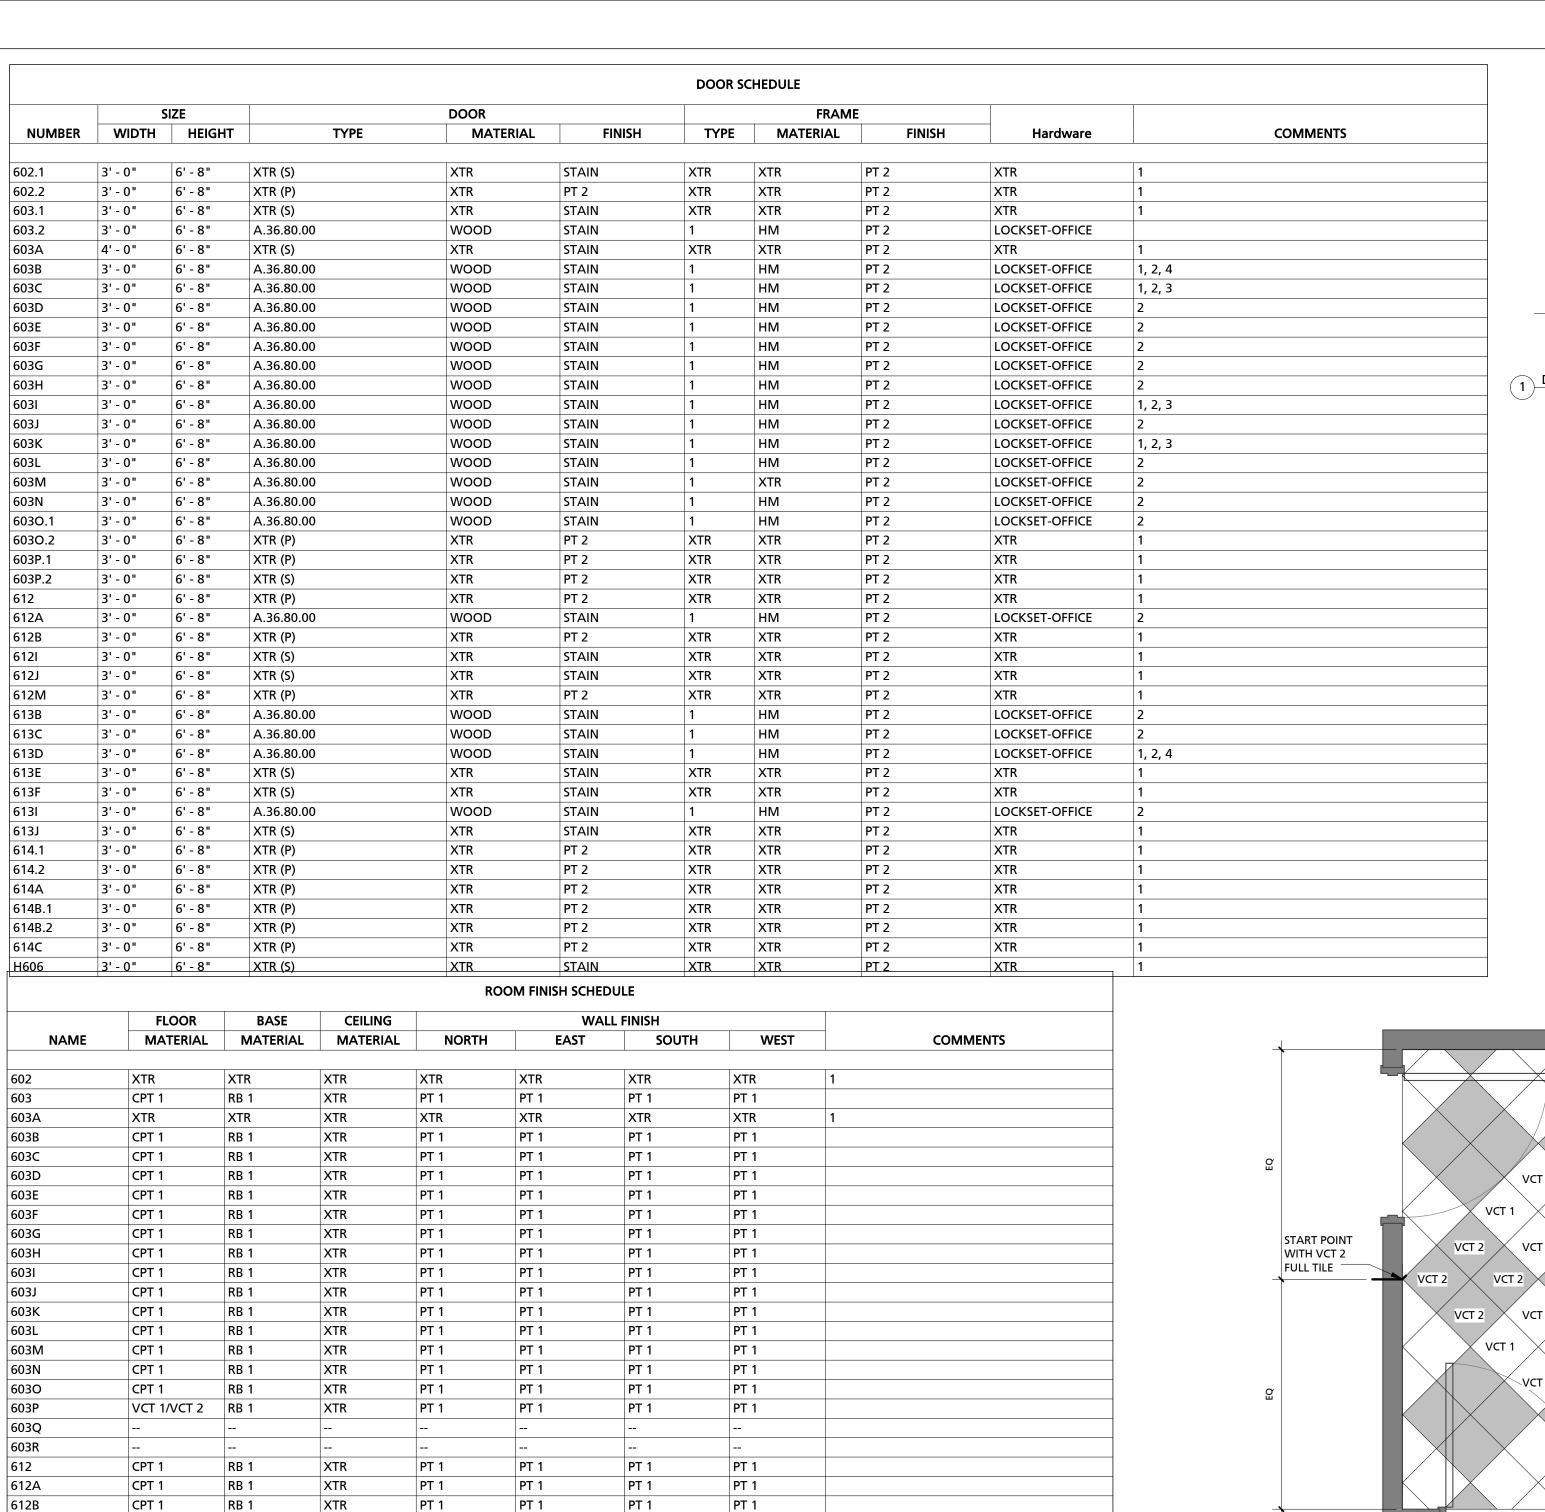

PT 1

XTR

PT 1

PT 1

PT 1

PT 1

PT 1

XTR

612C

612D 612E

612F

612G

612H

612I

612J

612K

612L

612M

613

613A

613B

613D

613E

613F

613G

613H

614 614A

614B

614C

614D 614E 614F 614G 614H

6141

614J 614K H606

H608

613C

CPT 1

XTR

CPT 1

CPT 1

CPT 1

CPT 1

VCT 1/VCT 2

RB 1

XTR

RB 1

RB 1

XTR

PT 1

XTR

PT 1

PT 1

PT 1

PT 1

PT 1

PT 3

PT 1


XTR


PT 1

PT 1


PT 1

PT 1

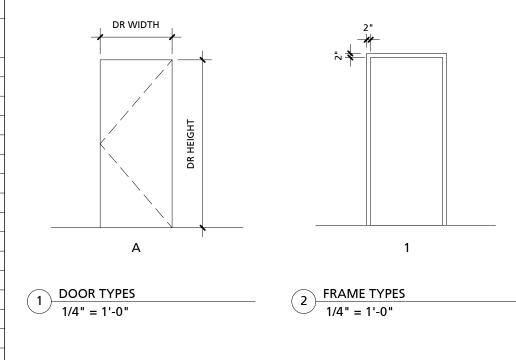

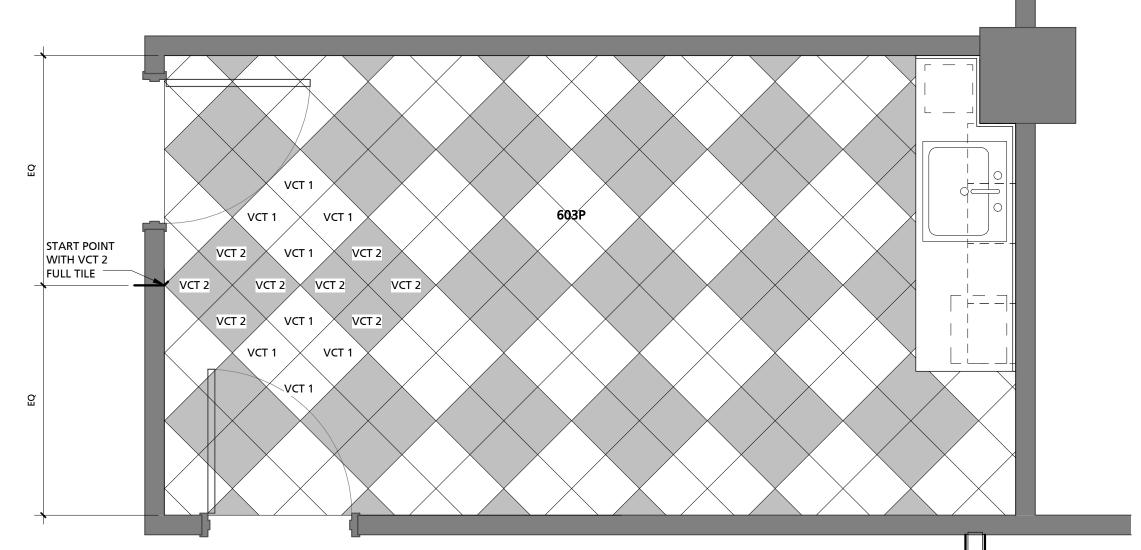

SIXTH FLOOR-FINISH PLAN AT 603P
1/2" = 1'-0"

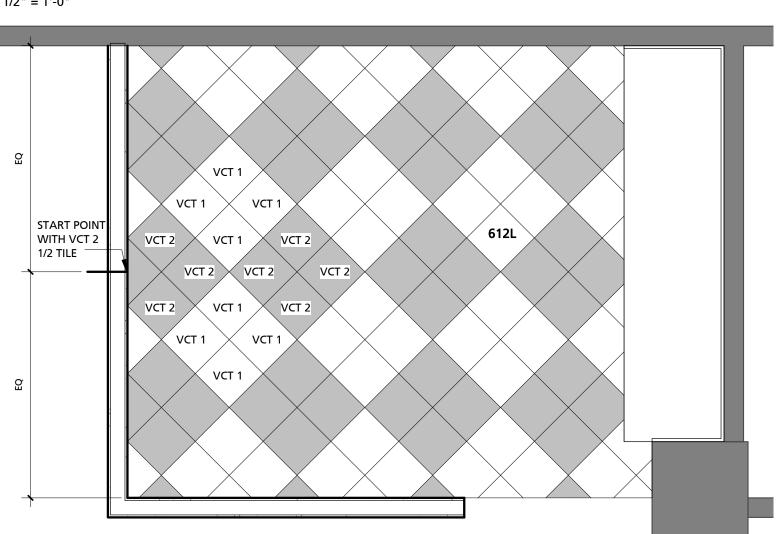

4 SIXTH FLOOR-FINISH PLAN AT 612L 1/2" = 1'-0"

GENERAL DOOR NOTES

- A. DOOR TYPE INDICATES DOOR TYPE, DOOR WIDTH (IN INCHES), DOOR HEIGHT (IN INCHES) AND RATING (IN MINUTES). FOIEXAMPLE, DOOR TYPE A.36.84 IS A
- DOOR TYPE "A", 36" IN WIDT84" IN HEIGHT. B. ALL DOORS TO BE LOCATED 6" FROM ADJACENT PERPENDICULAR WALL TO INSIDE FACE OF FRAME, UNLESS NOTED OTHERWISE. THIS DOES NOT APPLY TO

221 PICKENS STREET (29205)

POST OFFICE BOX 5875

COLUMBIA, SOUTH CAROLINA

29250

803.834.4048 p

803.834.4082 f

WWW.1X1DESIGN.COM

- STOREFRONT ITEMS. C. REFER TO A901 FOR FINISH DESIGNATIONS.
- D. CONTRACTOR TO VERIFY BUILDING STANDARD DOORS (TYPE AND SIZE). INTENT IS TO MATCH EXISTING ADJACENT DOORS ANIFRAMES. MATCH HARDWARE WITHIN SUITE.
- E. NEW DOORS TO BE STAINED TO MATCH EXISTING DOORS IN SUITE.
- F. DOOR HARDWARE LOCKSET/LATCHSET: TYPE: LEVER STYLE
- FINISH: 626/U626D PROVIDE LOCKSET WITH CORE TO MATCH BUILDING STANDARD OF CORBIN-RUSSWIN WITH A 6-PIN D KEYWAY.

G. COORDINATE KEYING WITH UNIVERSITY OF SOUTH CAROLINA KEY SHOP.

- DOOR SCHEDULE REMARKS
- 1. REFURBISH DOOR AND FRAME-MATCH EXISTING STAIN OR PAINT AS INDICATED. PAINT FRAME AS INDICATED.
- 2. STAIN NEW DOOR AND PAINT NEW FRAME
- 3. REUSE SALVAGED RH STAINED DOOR, HARDWARE, LOCKSET, AND FRAME. 4. REUSE SALVAGED LH STAINED DOOR, HARDWARE, LOCKSET, AND FRAME.

ROOM FINISH SCHEDULE REMARKS

1. EXISTING PAINT TO REMAIN - TOUCH-UP TO MATCH EXISTING PAINT, AS NEEDED.

ROOM FINISH SPECIFICATIONS

FLOORING: (BASIS OF DESIGN)

VCT 1 - VINYL COMPOSITION TILE

MFR: MANNINGTON STYLE: SOLID POINT COLOR: 317 COOL BEIGE SIZE: 12" X 12" X 1/8"

INSTALLATION: SEE PLANS

VCT 2 - VINYL COMPOSITION TILE

MFR: MANNINGTON STYLE: SOLID POINT COLOR: 322 IRON SIZE: 12" X 12" X 1/8" INSTALLATION: SEE PLANS

CPT 1 - CARPET TILE

MANNINGTON STYLE: TERES COLOR: 12220 CASHMERE SIZE: 24" X 24" INSTALLATION: VERTICAL ASHLAR

RB 1 - RUBBER COVE BASE

JOHNSONITE STYLE: VINYL COVE BASE COLOR: DC-178 IRON STONE CG

SIZE: 4" HIGH INTERIOR PAINT:

PT 1 - (FIELD COLOR)

SHERWIN WILLIAMS HARMONY COLOR: 6147 PANDA WHITE FINISH: EG-SHELL

PT 2 - (HOLLOW METAL DOOR AND FRAME)

SHERWIN WILLIAMS HARMONY COLOR: 7674 PEPPERCORN FINISH: SEMI-GLOSS

PT 3 - (ACCENT COLOR)


SHERWIN WILLIAMS HARMONY 6307 FINE WINE

EG-SHELL

GENERAL INTERIOR FINISH NOTES

FINISH:

- A. FOR FINISH LOCATIONS, REFER TO PLAN NORTH, SOUTH, EAST AND
- B. FIELD VERIFY ALL LOCATIONS FOR CASEWORK PLACEMENT, PRIOR TO FABRICATION. ENSURE ALL CLEARANCES ARE ME'ND ACCOUNTED FOR.
- NOTIFY CONTRACTOR OF ANY DISCREPANCIES IMMEDIATELY. C. ALL FINISHES TO MEET FLAME SPREAD REQUIREMENTS.

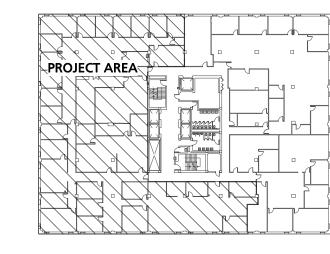

1600 HAMPTON STREET-SIXTH FLOOR KEY PLAN 1/64" = 1'-0"

20 EBRU, Ž D BIDI SED


U-13-111-3

20

UNIVERSIT

DOOR AND ROOM FINISH SCHEDULES

02.24.14

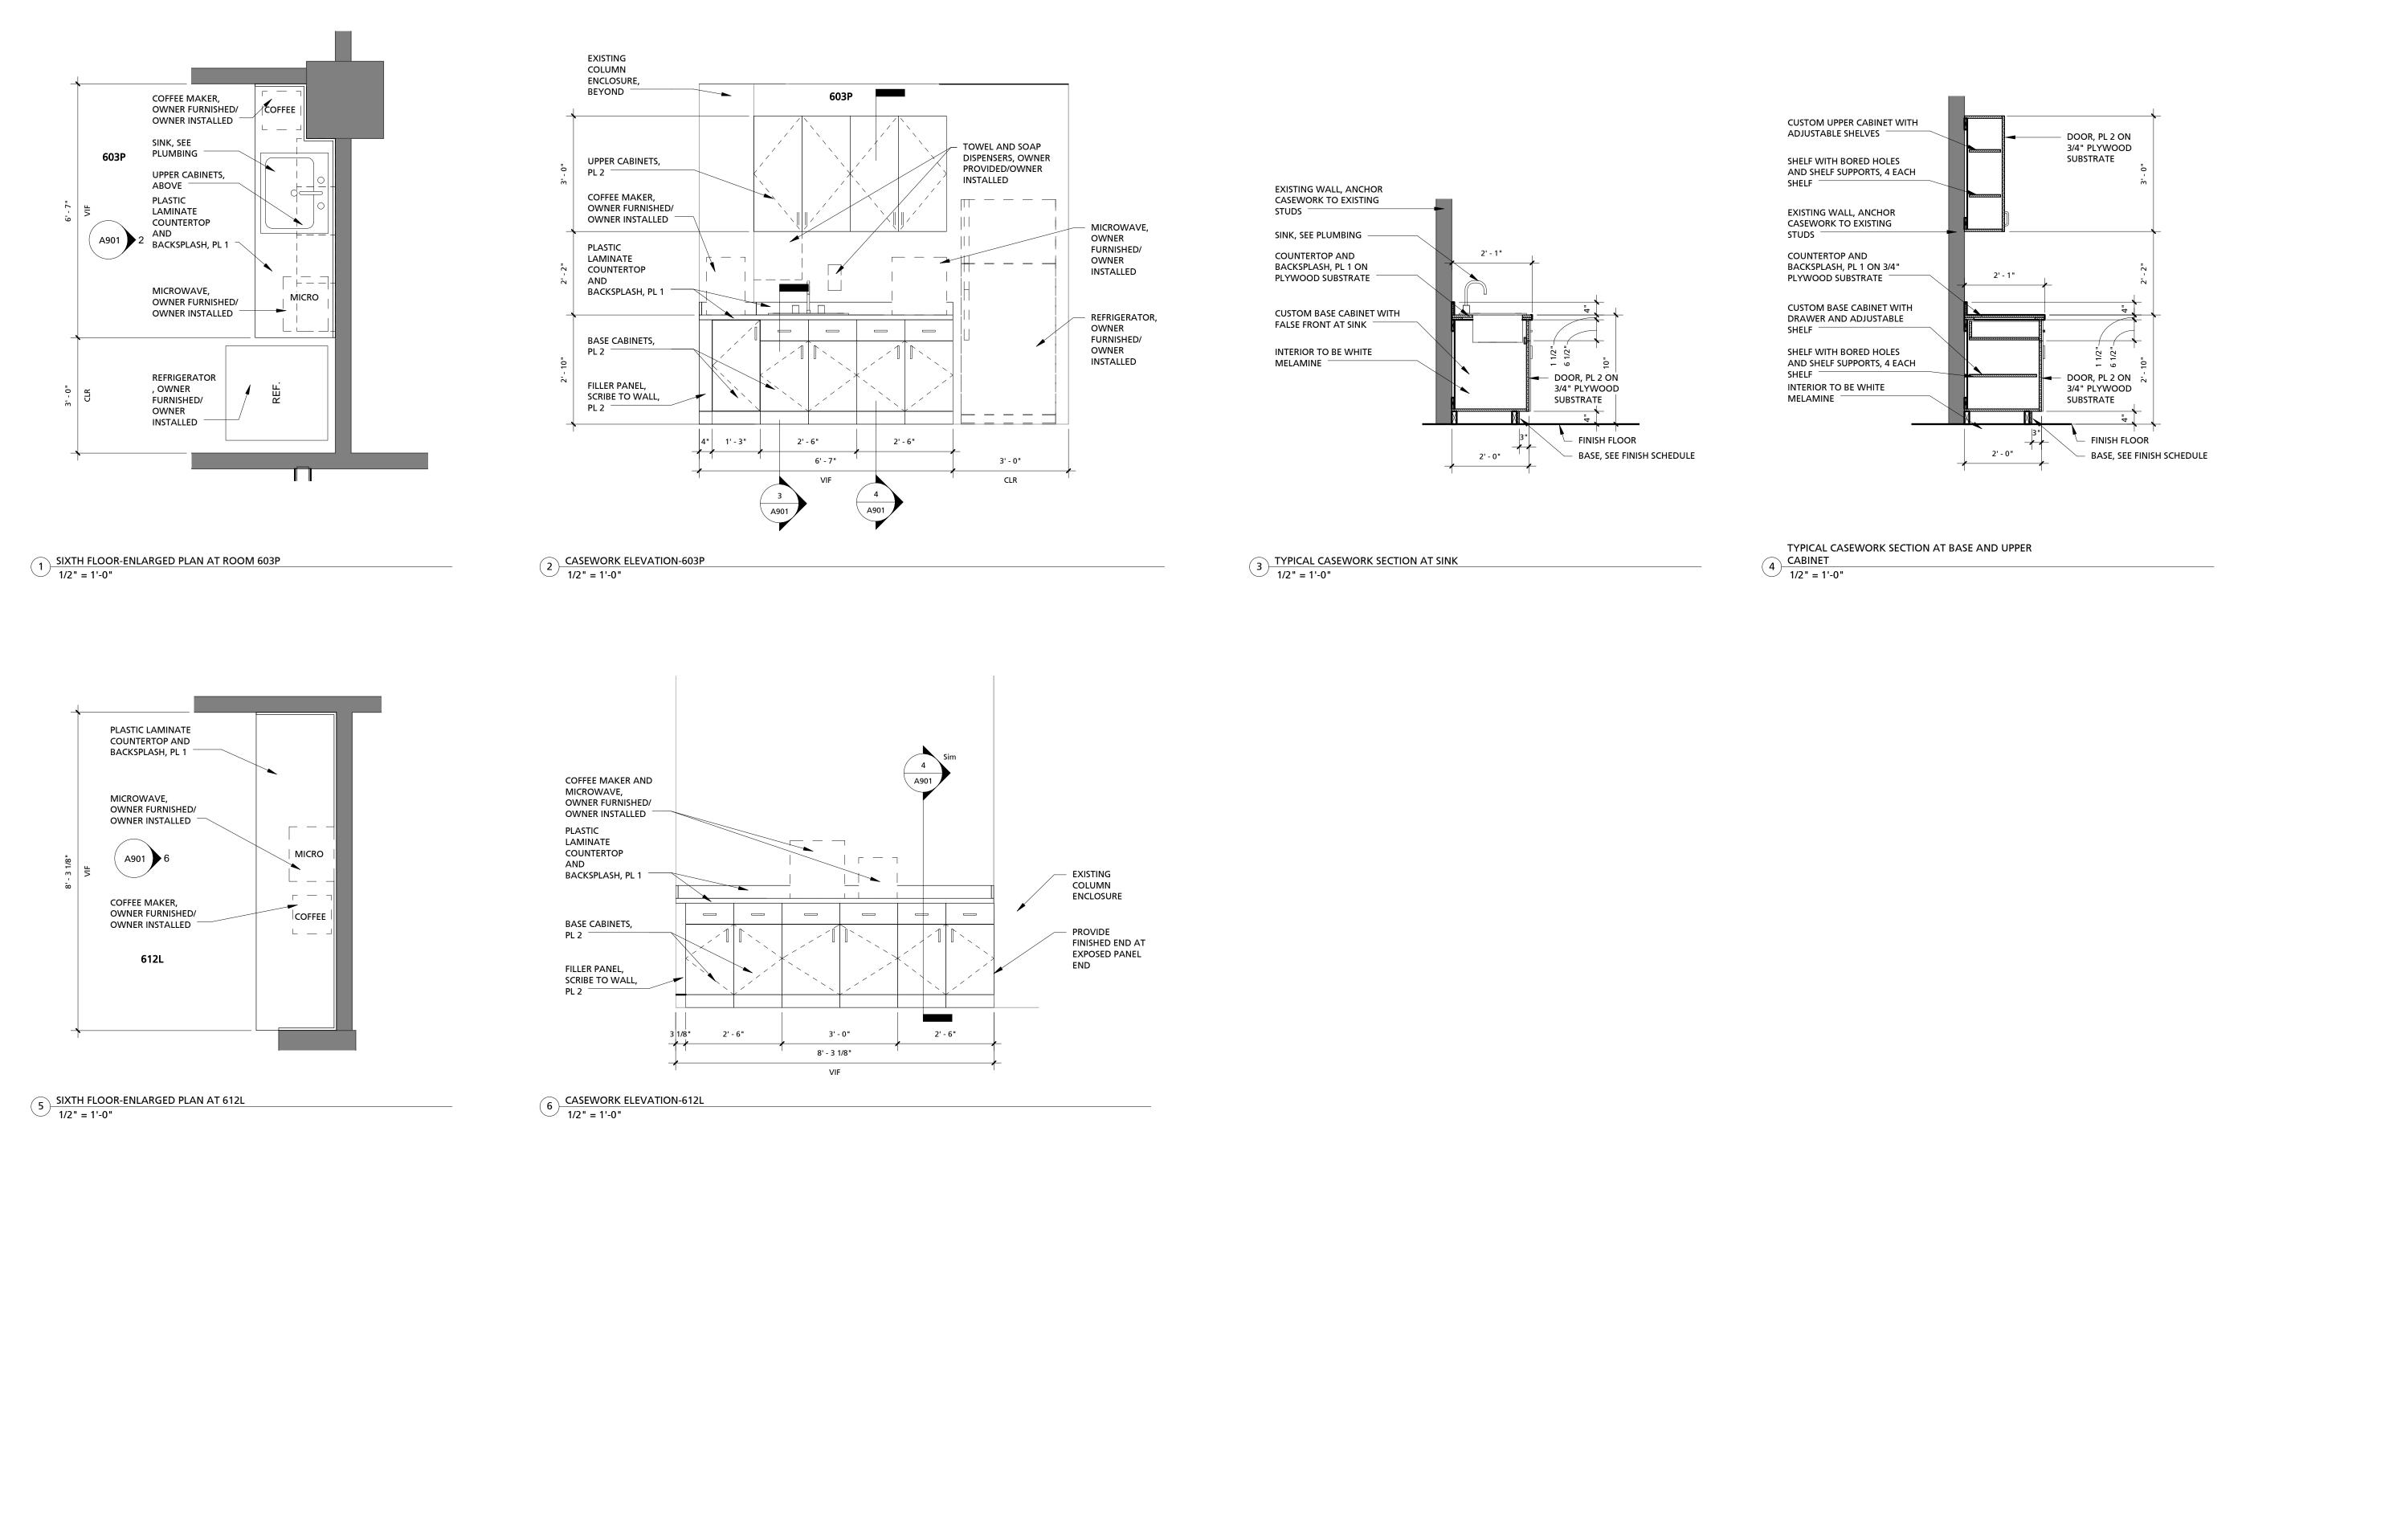

SOUTH UNIVERSITY 2014 **BIDDING-FEBRUARY** MILLWORK DETAILS 02.24.14

221 PICKENS STREET (29205)

POST OFFICE BOX 5875

COLUMBIA, SOUTH CAROLINA

29250

803.834.4048 p

803.834.4082 f

WWW.1X1DESIGN.COM




DEMOLITION NOTES


- PELOCATE EXISTING THERMOSTAT AS INDICATED ON HVAC RENOVATIONS SHEET M2.
- (D2) REMOVE EXISTING RUNOUT AND LIGHT TROUFFER SHOWN AS HATCHED COMPLETE. SEAL TRUNK DUCT AIR TIGHT AND PATCH AND REPAIR INSULATION.



DESG

221 PICKENS STREET (29205)
POST OFFICE BOX 5875
COLUMBIA, SOUTH CAROLINA
29250
803.834.4048 p
803.834.4082 f
WWW.1X1DESIGN.COM

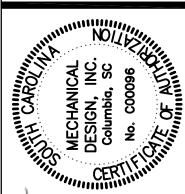

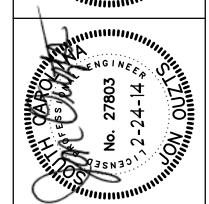



4403 Broad River Road Columbia, S.C. 29210 (803) 731-9834 (803) 731-9837 FAX

CONTACT: D. WILDS

DATE: 02/24/14

COMM. NO. 133034

NT NAME	UNIVERSITY OF SOUTH CAROLINA
JECT NAME	CONTROLLERS SUITE RENOVATION
IECT NUMBER	CP00377004
ECT ADDRESS	1600 HAMPTON STREET-SIXTH FLOOR, COLUMBIA, SC 29201

OR BIDDING-FEBRUARY 24, 2014
SKOISIANAME
SKOLECT NAME
PROJECT NAME
PROJECT NAME

U-13-111-3

SHEET NAME
6TH FLOOR HVAC
DEMOLITION PLAN

NOTES

- DO NOT SCALE DRAWINGS. ROUGH FROM ARCHITECTURAL, EXISTING CONDITIONS, AND EQUIPMENT MANUFACTURER'S DRAWINGS.
- DIMENSIONS ARE IN INCHES UNLESS OTHERWISE NOTED. DUCT SIZES SHOWN ON DRAWINGS ARE INTERIOR DIMENSIONS.
- 3. WHENEVER THE WORD "PROVIDE" IS USED IT SHALL MEAN FURNISH AND INSTALL COMPLETE AND READY FOR USE.
- 4. PROVIDE GLASSFAB AND MASTIC ON ALL DUCT INSULATION, SEE SPECIFICATIONS. DUCT TAPE WILL NOT BE ACCEPTED.
- 5. CONSTRUCT DUCTWORK AS JOB PROGRESSES AND AFTER COOR-DINATING WITH ALL CONCERNED TRADES AND EXISTING CONDITIONS.
- 6. SEE SPECIFICATIONS FOR FLEXIBLE DUCT REQUIREMENTS.
- WHERE DUCTS PASS OVER RECESSED LIGHTING FIXTURES, MAINTAIN I" CLEARANCE FROM TOP OF FIXTURE TO BOTTOM OF DUCT.
- 8. INSTALLATION OF EQUIPMENT, DUCTWORK, AND PIPING, INCLUDING VIBRATION ISOLATION SHALL COMPLY WITH 2012 INTERNATIONAL BUILDING CODE FOR SEISMIC PROTECTION. SEE SPECIFICATIONS.
- WHERE SPIN-IN TAKEOFFS ARE LOCATED ABOVE INACCESSIBLE CEILINGS, OMIT DAMPER.
- 10. THE MINIMUM DISTANCE BETWEEN TAKEOFFS ON THE SAME SIDE OF THE DUCTS SHALL BE FOUR (4) TIMES THE DIAMETER OF THE FIRST

RENOVATION NOTES

- RI) RELOCATE EXISTING THERMOSTAT AS INDICATED ON HVAC RENOVATIONS SHEET M2.
- RELOCATE EXISTING TROUFFER AS INDICATED. REPLACE EXISTING RUNOUT DUCT AS REQUIRED. FIELD VERIFY EXACT DIAMETER OF RUNOUT DUCT.

	SYMBOLS				
~~~~	FLEXIBLE DUCT (6 FT. MAX. LENGTH)				
<del>, , , , , , , , , , , , , , , , , , , </del>	RIGID ROUND RUNOUT DUCT				
	NEW MATERIAL				
<u> </u>	MATERIAL TO BE REMOVED				
CFM	AIR FLOWRATE, CUBIC FEET PER MINUTE				
1 100	GRILLE OR DIFFUSER MARK, BALANCING CFM				
	SPIN-IN TAKEOFF WITH SCOOP AND DAMPER				
	MANUAL DAMPER WITH LOCKING QUADRANT				
(†)	THERMOSTAT				
•	CONNECT NEW TO EXISTING				


GRILLE AND DIFFUSER SCHEDULE							
MARK	SERVICE	NECK SIZE	MAX CFM		RUNOUT SIZE		REMARKS
1	SUPPLY	6"¢	110		6"¢	W/	BUTTERFLY DPR.
10	RETURN	10"×10"	340		10"x8"		
E	EXIST	EXISTING DIFFUSER, BALANCE TO CFM INDICATED					DICATED
	RILLE/ FFUSER	CEILII TYP		1	PRICE * 10DEL NO.		MATERIAL
SQUAF	RE SUPPLY	LAY-	IN		SPD-31		STEEL
SQUAF	RE SUPPLY	GYP.	3D.		SPD-31		STEEL
SQUAF	RE RETURN	LAY-	IN		81-TB		ALUMINUM
SQUAF	RE RETURN	GYP. E	3D.		81-F-A		ALUMINUM

- * OR EQUAL BY CARNES, METALAIRE, NAILOR, KREUGER OR APPROVED EQUAL.
- NOTES: 1. GRILLE AND DIFFUSER LOCATIONS SHOWN ON FLOOR PLANS ARE APPROXIMATE, SEE ARCHITECTURAL REFLECTED CEILING PLAN FOR EXACT LOCATION.
  - 2. GRILLES AND DIFFUSERS SHALL MATCH CEILING TYPE, SEE ARCHITECTURAL DRAWINGS FOR CEILING TYPE.
  - 3. GRILLE AND DIFFUSER COLORS SHALL BE SELECTED BY ARCHITECT, SUBMIT COLOR SAMPLES TO ARCHITECT.
  - 4. LAY-IN EGGCRATE SHALL HAVE FULL FACE (24x24) AND FULL SIZE STEEL BACK PLATE WITH DUCT CONNECTOR COLLAR. INTERIOR OF GRILLE SHALL BE FLAT BLACK.



221 PICKENS STREET (29205) POST OFFICE BOX 5875 COLUMBIA, SOUTH CAROLINA 803.834.4048 p 803.834.4082 f WWW.1X1DESIGN.COM



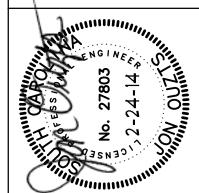

MECHANICAL DESIGN INC.

4403 Broad River Road Columbia, S.C. 29210 (803) 731-9834 (803) 731-9837 FAX

CONTACT: D. WILDS DATE: 02/24/14сомм. No. 133034

CAROLINA

SOUTH UNIVERSITY

2014 Description

BIDDING-OR

6TH FLOOR HVAC RENOVATIONS PLAN


6TH FLOOR HYAC RENOVATIONS PLAN


### AIR CHAMBER DETAIL

NO SCALE

SPECIAL NOTES:

- I. (IPC) PLUMBING CODE PARAGRAPH 604.9 APPLIES TO QUICK-CLOSING YALYES ONLY.
- 2. THIS PROJECT DOES NOT CONTAIN QUICK-CLOSING VALVES.

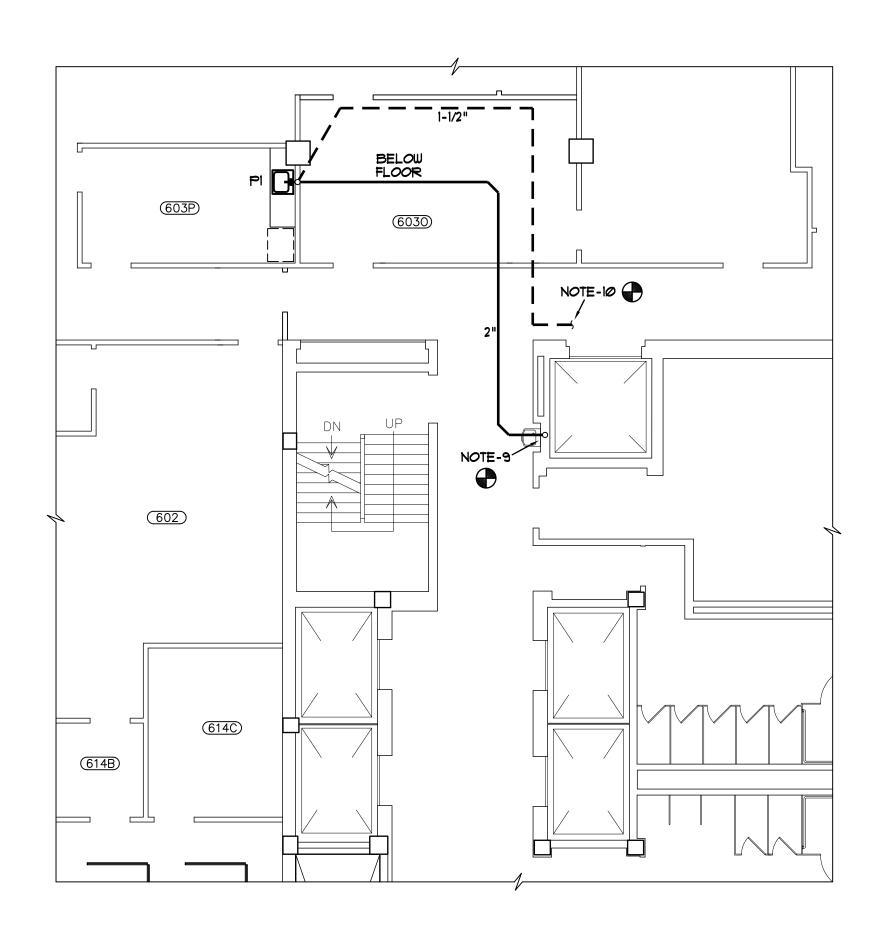

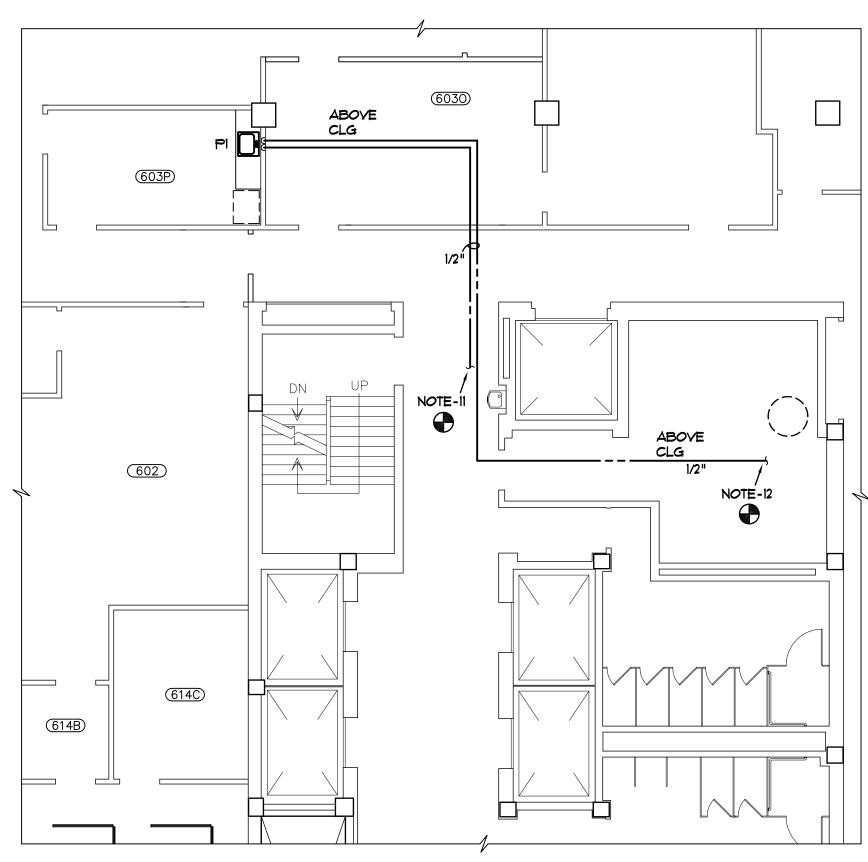

### WASTE AND VENT PIPING

for larger pipes.

1.6 <u>INSULATION</u>:

1.7 <u>FIXTURES</u>:

### WATER PIPING

# PLUMBING FLOOR PLANS - 6TH FLOOR

CONTRACTOR IS REQ'D TO VISIT PROJECT SITE PRIOR TO SUBMITTING BID AND THOROUGHLY FAMILIARIZE HIMSELF WITH ALL EXIST CONDITIONS RELATING TO THIS PROJECT. SUBMISSION OF A BID WILL BE CONSIDERED AS EVIDENCE THAT THE CONTRACTOR HAS VISITED THE SITE OF WORK.

### PLUMBING SPECIFICATIONS

C. Support copper pipe with copper or copper plated hangers,

A. All insulation material shall have a fire hazard classification

B. Domestic hot and cold water piping shall be insulated with

1. Pipe fittings shall be insulated with same material and

Type III, Class 12; NFPA 90A and MIL-1-223.

C. Plumbing fixture shall be as specified below:

1" thick one-piece fiberglass insulation with ASJ embossed

thickness as pipe. Install PVC jacket for all pipe insulation

fittings. Insulation shall conform to HH-1-558B, Form D,

C. Insulation shall be cut, mitered and sealed with mastic in a neat

and professional manner. Poor insulation installation will not be

A. Provide stop valves for sink. Stop valves shall be furnished complete

with 3" c.p. brass nipples and c.p. brass set screw escutcheons.

B. Stainless steel sink shall be as manufactured by Elkay or equal by

P1 1-Comp Sink; Elkay LRAD(Q)25224, 25"x22"x6-1/2" deep self-

rimming 18 ga SS ADA compliant single compartment sink, (3) hole

punch, 4" centers, rear drain outlet, Delta 100—DST single handle

mixing faucet w/9" swing gooseneck, RP19754 1.5 GPM aerator.

Provide Snap-N-Loc strainer, McGuire H165C heavy supplies and

accepted. provide PVC covers and wrap at exposed insulation.

barrier, joint sealing tapes, mastic and fittings.

vapor barrier laminated jacket.

Just will be accepted.

8912 1-1/2"p-trap.

spaced not over 6 feet apart for 1/2" pipe and 8 feet apart

not to exceed flame spread of 25 and smoke developed rating

of 50, as listed by Underwriters Laboratories and acceptable

under NFPA standards. This applies to the complete system

and to the composite insulation with jacket or facings, vapor

SCALE: 1/8" ===1'-Ø"

1.1 <u>SCOPE</u>:

A. Provide all related equipment, labor, materials, excavation and backfill, operations and accessories required for the installation of complete and quietly operating plumbing systems, in accordance with the plans and specifications. This shall include the following:

- 1. Waste, Drain and Vent Piping
- 2. Domestic Hot and Cold Water Pipina
- 3. Domestic Water Valves
- 4. Pipe Hangers and Supports 5. Pipe Insulation
- 6. Fixtures
- 7. Sterilization of Domestic Water Piping and Certificates
- 8. Tests 9. Guarantees

1.2 <u>WASTE, DRAIN AND VENT PIPE</u>:

A. Waste, drain and vent piping be service weight No-Hub cast iron pipe and fittings in accordance with ASTM A74. Couplings shall be medium duty CISPI as mfr'd by Mission, Ideal or Anaheim (Husky).

1.3 <u>DOMESTIC HOT AND COLD WATER PIPING</u>:

A. Domestic hot and cold water pipe to be hard drawn copper, Type L with soldered wrought copper fittings. Use lead—free hard solder (95—5) for all joints. Use soldering nipples or couplings between screwed and soldered pipe and fittings.

1.4 DOMESTIC WATER VALVES:

- A. Provide valves where indicated on drawings. Valves shall be sized according to line sizes indicated.
- B. Valves shall be Class 125 designed for a minimum of 125 psi steam working pressure. The manufacturer name and the working pressure to be cast on valve body.
- C. Valves to be the product of Hammond, Nibco, Milwaukee or Apollo.

1.5 PIPE SUPPORTS:

- A. Perforated strap hangers, chain or wire will not be permitted <u>on the job</u>.
- B. Support horizontal piping above ground with hangers, threaded rods and turnbuckles as manufactured. by Grinnell, PHD Hangers, or approved equal.

1.8 STERILIZATION OF HOT AND COLD WATER SYSTEMS:

- A. Sterilize with a solution containing not less than (50) parts per million of available chlorine. Use sodium hypochlorite solution conforming to Federal Specifications OB-441-A, Grade D. Solution to remain in system for (24) hours, opening and closing all valves several times. After sterilization, flush with clean water until chlorine is not greater than 0.2 parts per million.
- B. Have samples collected from throughout the systems on (2) consecutive days tested by an approved independent testing lab and deliver certificates of approval to County Sanitarian and Owner. All laboratory fees shall be included in the plumbing contract. Contractor shall be responsible for preventing use of water from systems for human consumption until tested and approved. Should any of the tests prove unfavorable, the entire disinfection and sampling process shall be repeated.
- C. After the (24) hour retention period of the disinfection solution, the treated water should contain no less than 25 mg/l chlorine throughout the length of pipe.
- D. Certificates indicating negative results of bacteriological test shall be procured prior to building acceptance.

1.9 <u>TESTS</u>:

- A. Pressure and leak test all water piping at minimum 150 PSI for 4 hours and in accordance with local requirements.
- B. Test waste and venting pipe systems by plugging all necessary openings and filling systems with minimum 10'-0" water column or to the top of the highest vent stack.

1.10 GUARANTEE:

- A. Contractor shall guarantee all equipment, piping and any other materials specified under this Division of the contract for a period of one (I) year from the date of project acceptance unless otherwise indicated. Upon failure of any part(s) of the system during the guarantee period, the affected part(s) shall br repaired or replaced promptly by and at the expense of the Contractor.
- B. If any component fails during the regular one year period, then the replacement part(s) shall be given an additional one (1) year guarantee from the time of replacement. This shall continue until the items have given one (I) year satisfactory service.

END OF SPECIFICATIONS

### PLUMBING FIXTURE SCHEDULE

SYMBOL	DESCRIPTION	CW	H	WASTE	VENT	MOUNTING HEIGHT
PI	1-COMP SINK	1/2"	1/2"	2"	1-1/2"	SEE ARCH

### PLUMBING NOTES


- DO NOT SCALE DRAWINGS. ROUGH FROM ARCHITECTURAL AND EQUIPMENT MANUFACTURER'S DRAWINGS.
- . COORDINATE PLUMBING SYSTEMS WITH ALL TRADES TO AVOID INTERFERENCE AND CONFLICTS PRIOR TO INSTALLATION OF PIPING, FIXTURES, AND EQUIPMENT.
- 3. ALL WORK AND MATERIALS SHALL BE IN ACCORDANCE WITH THE (IBC) BUILDING AND (IPC) PLUMBING CODES, 2006 EDITIONS OF THE (ICC) INTERNATIONAL CODE COUNCIL AND ALL LOCAL CODES AND ORDINANCES.
- 4. WHENEVER THE WORD "PROVIDE" IS USED, IT SHALL MEAN FURNISH AND INSTALL COMPLETE AND READY FOR USE.
- 5. UNLESS OTHERWISE SHOWN OR NOTED, ALL PIPING SHALL BE RUN CONCEALED IN WALLS, CHASES AND/OR ABOVE CEILINGS.
- 6. PROVIDE AIR CHAMBERS ON HOT AND COLD WATER SUPPLY TO EACH FIXTURE. SIZE ONE PIPE SIZE LARGER THAN SUPPLY. (SEE DETAIL, THIS SHT)
- LOCATE GATE VALVES ABOVE CEILING TO PERMIT EASY ACCESS. (SEE NOTE-2)
- 8. INSTALLATION OF EQUIPMENT AND PIPING SHALL COMPLY WITH THE (IBC) BUILDING CODE 2006 EDITION FOR SEISMIC PROTECTION.
- 9. PROVIDE CONNECTION TO EXIST 2" WASTE RISER AT EXISTING ELECTRIC WATER COOLER AS REQUIRED.
- 10. EXTEND 1-1/2"YENT ABOVE CLG AND PROVIDE CONNECTION TO EXIST 2" VENT RISER AT EXISTING ELECTRIC WATER COOLER AS
- EXTEND 1/2"CW ABOYE CLG AND PROVIDE CONNECTION TO EXIST 1/2"CW AT ELECTRIC WATER COOLER AS REQUIRED.
- 12. EXTEND 1/2"HW ABOVE CLG AND PROVIDE CONNECTION TO EXIST I"HW AT HEATER AS REQUIRED.

### PLUMBING SYMBOLS

SYMBOL	DESCRIPTION
	SANITARY WASTE PIPING
	SANITARY VENT PIPING
	COLD WATER PIPING
	HOT WATER PIPING (120°F)
H	GATE VALVE
CW, HW	COLD WATER, HOT WATER
EWC	ELECTRIC WATER COOLER

### TYPICAL PLUMBING DEMOLITION NOTES


- DI. CONTRACTOR SHALL FIELD COORDINATE AND VERIFY EXIST CONDITIONS PRIOR TO START OF DEMOLITION WORK. NOTIFY ENGINEER IMMEDIATELY IF QUESTIONS OR CONFLICTS ARE DISCOVERED AT START OF PROJECT.
- D2. PROVIDE SAWCUTTING, CUTTING, CORE DRILLING AND REMOVAL OF EXIST FLOOR SLABS AND/OR EXIST WALLS AS REQUIRED FOR THE INSTALLATION OF PLUMBING SYSTEMS. CONTRACTOR SHALL COORDINATE ALL DEMOLITION OF EXIST SURFACES WITH THE GENERAL CONTRACTOR TO MAINTAIN MINIMAL AMOUNT OF CUTTING AS REQUIRED. PATCHING OF EXIST FINISHED SURFACES SHALL BE BY THE GENERAL CONTRACTOR.
- D3. REMOVAL, STORAGE AND REINSTALLATION OF EXISTING CEILING TILES SHALL BE THE RESPONSIBILITY OF THE GENERAL CONTRACTOR. THE PLUMBING CONTRACTOR SHALL WORK WITHIN THE EXISTING CEILING GRID WHERE APPLICABLE.

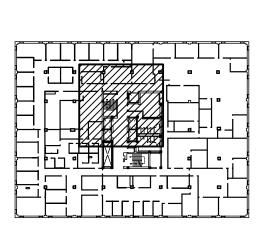

<u>KEYPLAN</u> NO SCALE

221 PICKENS STREET (29205) POST OFFICE BOX 5875 COLUMBIA, SOUTH CAROLINA 29250 803.834.4048 p 803.834.4082 f WWW.1X1DESIGN.COM



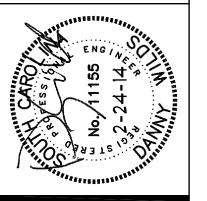



4403 Broad River Road Columbia, S.C. 29210 (803) 731-9834 (803) 731-9837 FAX

CONTACT: M. HENDRIX 02/24/14 сомм. No. 133034

IVERSITY OF SOUTH CAROLINA ROLLERS SUITE RENOVATION
77004


	^INO	CONTROI	CP00377004	0007
4, 2014	CLIENT NAME	PROJECT NAME	PROJECT NUMBER	

REVISIONS	6		
No.	Description		С
			_
PROJECT NUME	BER	U-1:	3-
SHEET NUMBER	₹		

Ρ'

PLUMBING FLOOR PLANS -6TH FLOOR 02.24.14

REL

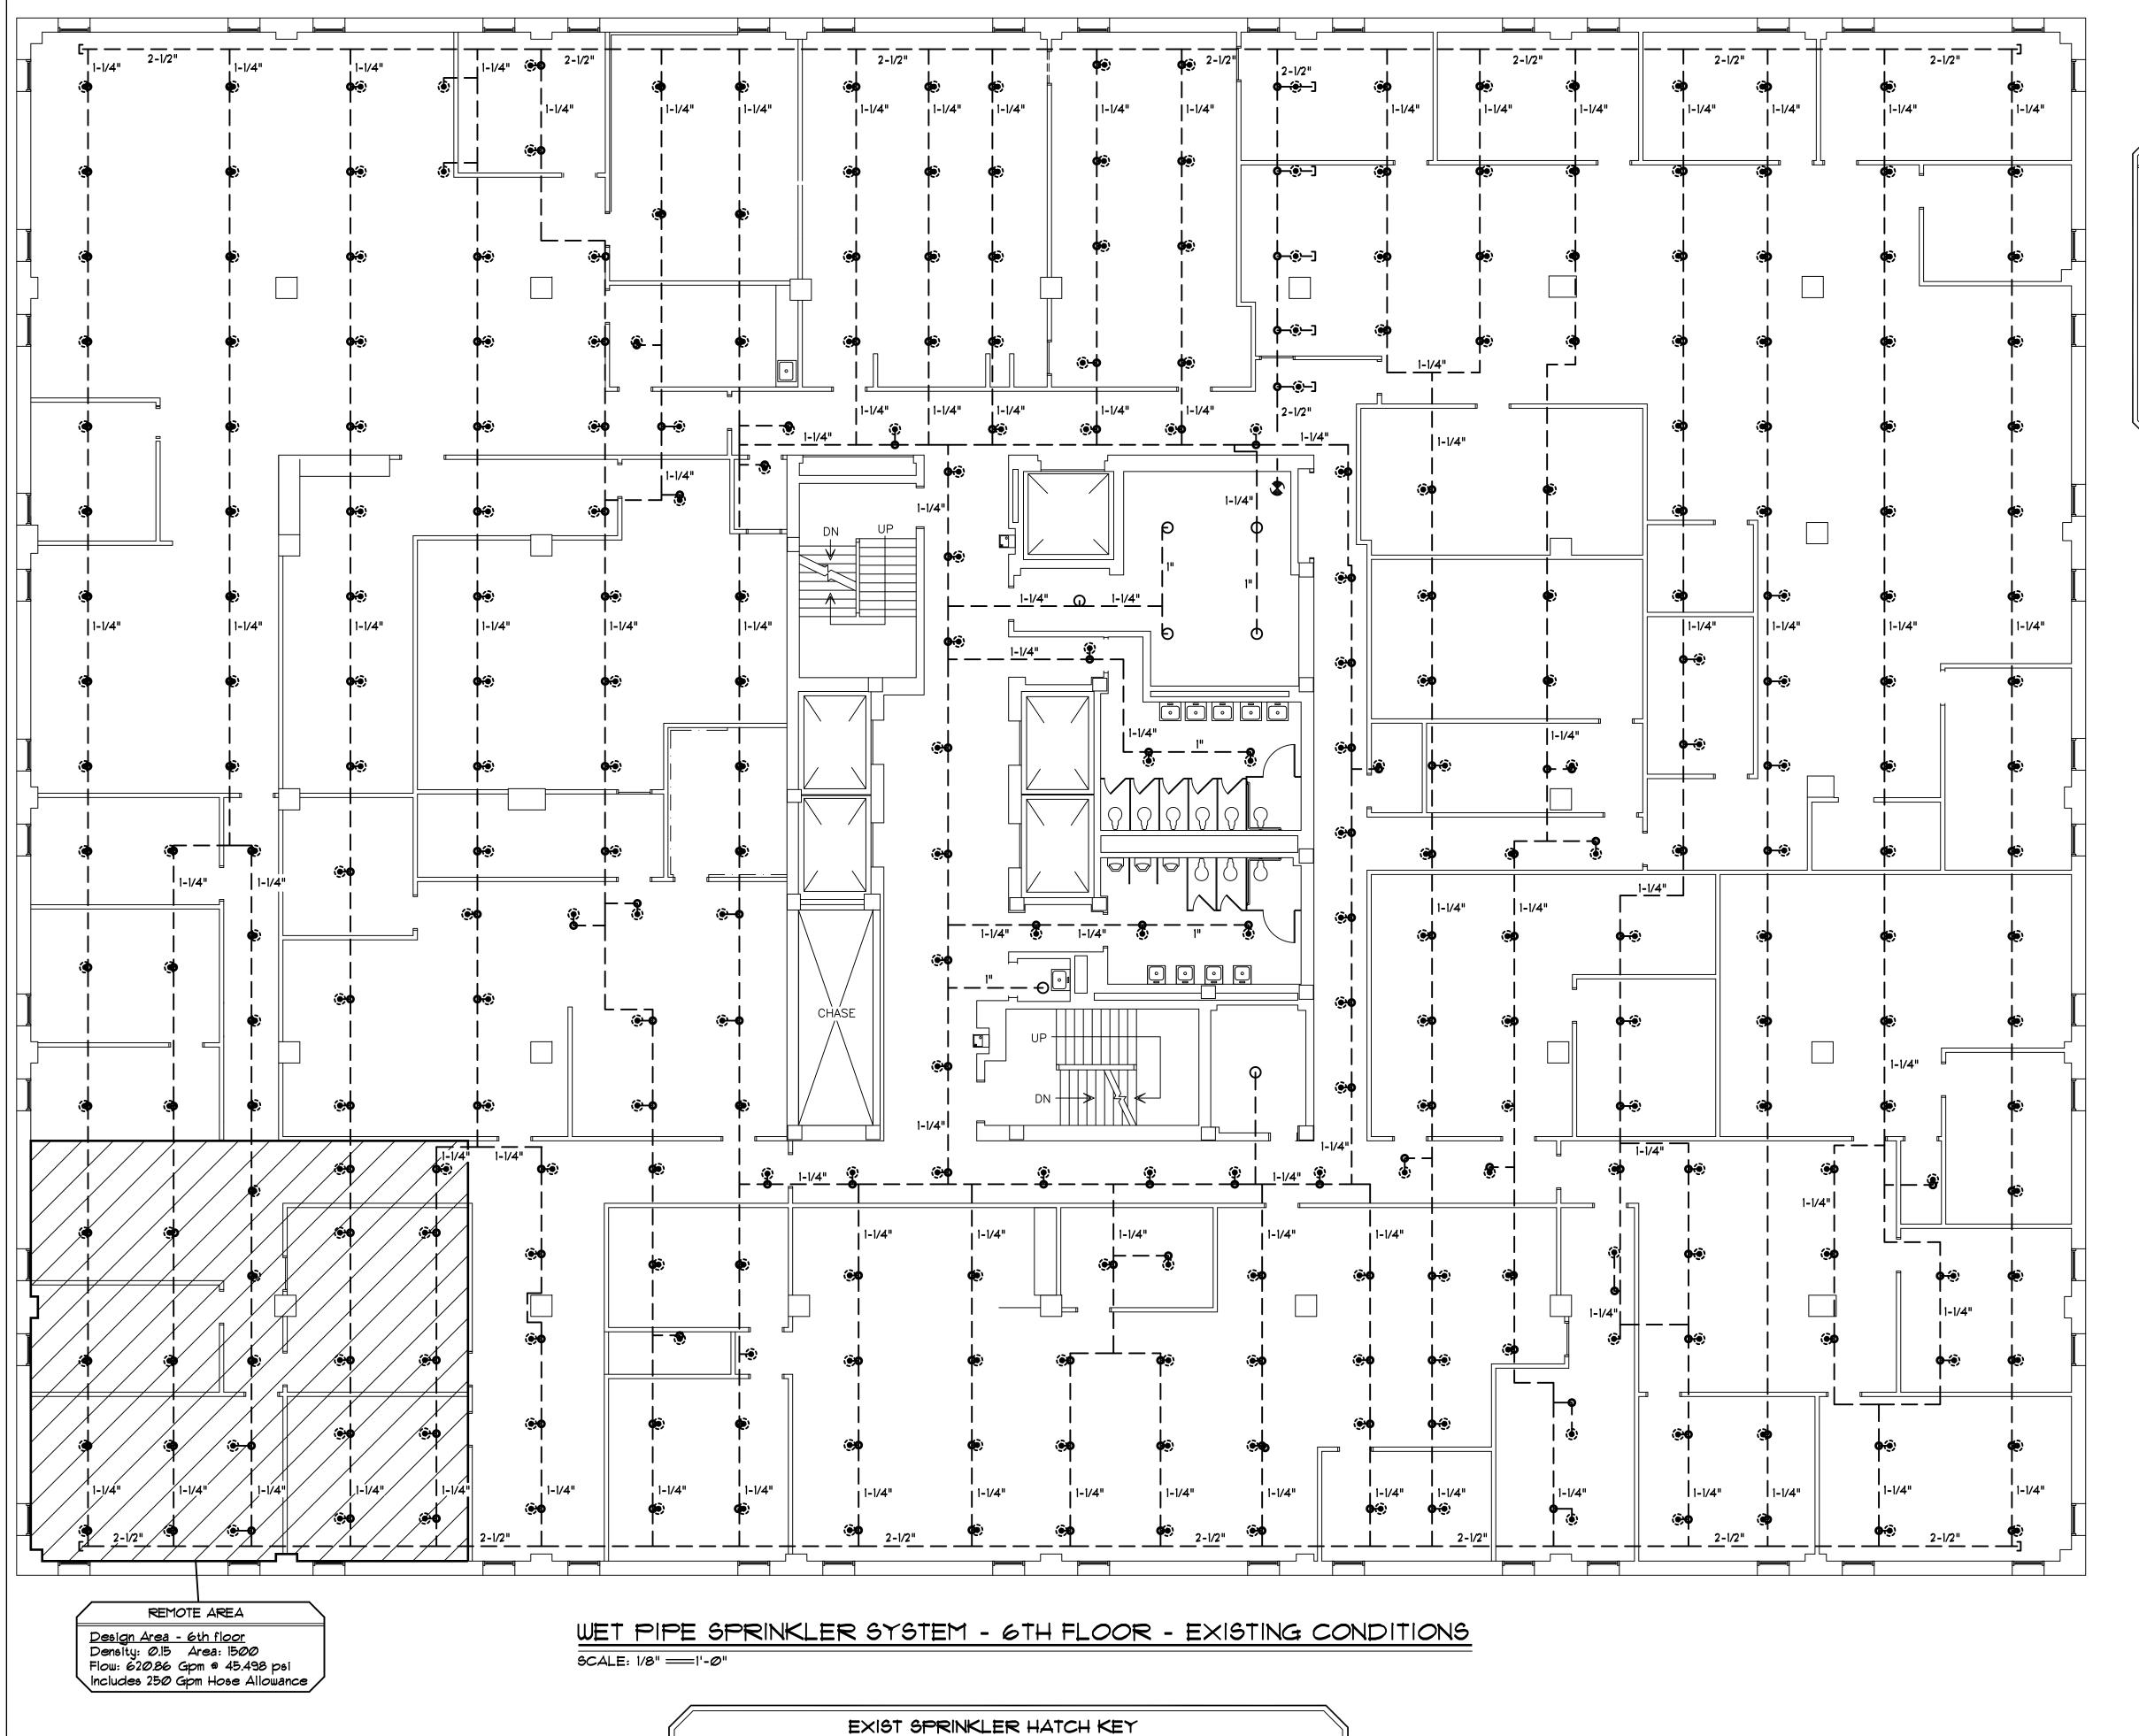

DESCRIPTION

VK300 VIKING MFQR UPRIGHT

1/2" VK302 VIKING MFQR SEMI-RECESSED CHROME PENDENT

SYMBOL | DEGREE | SIZE | S.I.N. # |

200


1/2"




- A. LOCATIONS OF SPRINKLER HEADS, PIPING AND PIPE SIZES ARE BASED ON SPRK SHT 9 OF 10 FURNISHED BY CRAWFORD SPRINKLER CO., REVISION DATE 10-20-03.
- B. CONTRACTOR SHALL FIELD YERIFY EXACT LOCATIONS OF ALL EXISTING PIPING AND HEADS INCLUDING LINE SIZES AND SPRK HEAD TYPES TO ESTABLISH EXIST CONDITIONS PRIOR TO SUBMITTING A BID FOR THIS
- C. EXISTING SEISMIC BRACING FOR MAINS AND BRANCH LINES SHALL REMAIN. CONTRACTOR SHALL PROVIDE SEISMIC BRACING FOR ALL MODIFICATIONS AS REQUIRED IN ACCORDANCE WITH NFPA-13.
- D. RECORD DRGS FOR THIS PROJECT SHALL INCLUDE LOCATIONS OF ALL EXISTING PIPING TO REMAIN.
- E. EXISTING SPRINKLER PIPING INCLUDING SPRINKLER HEAD DROPS IS METALLIC PIPING.

221 PICKENS STREET (29205)

POST OFFICE BOX 5875 COLUMBIA, SOUTH CAROLINA 29250 803.834.4048 p 803.834.4082 f WWW.1X1DESIGN.COM

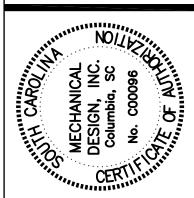

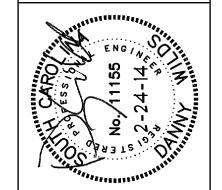



4403 Broad River Road Columbia, S.C. 29210 (803) 731-9834 (803) 731-9837 FAX

CONTACT: M. HENDRIX DATE: 02/24/14сомм. No. 133034

Description EBRUAR U-13-111-3

FP1 WET PIPE SPRK SYSTEM -6TH FLR - EXIST CONDITIONS 02.24.14

CONTRACTOR IS REQ'D TO VISIT PROJECT SITE PRIOR TO SUBMITTING BID AND THOROUGHLY FAMILIARIZE HIMSELF WITH ALL EXIST CONDITIONS RELATING TO THIS PROJECT. SUBMISSION OF A

AREA OF WORK

<u>KEYPLAN</u>

NO SCALE

SPECIAL NOTE:

BID WILL BE CONSIDERED AS EVIDENCE THAT THE CONTRACTOR HAS VISITED THE SITE OF WORK.

WET PIPE SPRINKLER SYSTEM - 6TH FLOOR

SCALE: 1/8" ===1'-0"

### SPRINKLER HEAD NOTES


- SI. REFER TO ARCHITECTURAL DRAWINGS FOR REFLECTED CEILING PLANS.
- 52. REWORK EXIST SPRINKLER PIPING AS REQUIRED FOR THE INSTALLATION OF SUSPENDED CEILINGS AND MODIFICATIONS FOR ALL SPRK HEAD
- 53. MODIFY EXIST PIPING TO ACCOMMODATE SPRINKLER HEAD LOCATIONS INCLUDING FINAL CEILING HEIGHTS AS APPLICABLE.
- 54. SPRINKLER HEAD MANUFACTURER'S AND TYPES SHALL MATCH EXIST. PROVIDE SEMI-RECESSED PENDENT HEADS IN ALL FINISHED CEILINGS.
- 95. LOCATE SPRINKLER HEADS IN CENTER OF CEILING TILES. COORDINATE WITH LIGHTING AND MECHANICAL DIFFUSER LOCATIONS PRIOR TO INSTALLATION TO PREVENT CONFLICTS.
- 56. ALL WORK AND MATERIALS SHALL BE IN ACCORDANCE WITH NFPA-13
- 57. CONTRACTOR SHALL PROVIDE ALL RENOVATIONS IN ACCORDANCE WITH NFPA-25 2010 AND STATE FIRE MARSHAL AS APPLICABLE.
- 58. PROVIDE DEMOLITION AND REPLACEMENT OF ALL EXIST SPRK HEADS IN ALL AREAS OF WORK. THIS INCLUDES LOCATIONS OF MECHANICAL EQPT, DUCTS, LIGHTS, ETC.
- S9. SPRK PIPING SHALL BE UL LISTED METALLIC PIPE WITH IDENTIFICATION IN ACCORDANCE WITH NFPA 13.


### CURRENT FLOW TEST

CONTRACTOR IS REQ'D TO OBTAIN CURRENT FIRE FLOW TEST DATA PRIOR TO BIDDING THIS PROJECT TO VERIFY EXIST CONDITIONS AND FOR SUBMISSION OF FSSSS AND COC TO STATE FIRE MARSHAL AS REQUIRED.



POST OFFICE BOX 5875 COLUMBIA, SOUTH CAROLINA 29250 803.834.4048 p 803.834.4082 f WWW.1X1DESIGN.COM

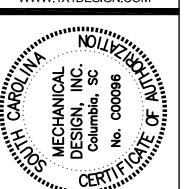

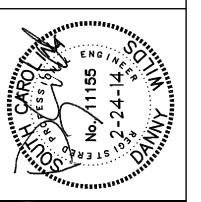


MECHANICAI DESIGN

4403 Broad River Road Columbia, S.C. 29210 (803) 731-9834 (803) 731-9837 FAX

CONTACT: M. HENDRIX 02/24/14 сомм. No. 133034

<b>4</b> 0	
NAME	UNIVERSITY OF SOUTH CAROLINA
ST NAME	CONTROLLERS SUITE RENOVATION
T NUMBER	CP00377004
TADDRESS	1600 HAMPTON STREET-SIXTH FLOOR, COLUMBIA, SC 29201

WET PIPE SPRK SYSTEM -6TH FLR

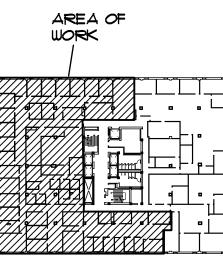

KEYPLAN NO SCALE


PARTIAL SIXTH FLOOR POWER DEMOLITION PLAN


**₽** E

BEA ENGINEERING ASSOCIATES. ASSOCIATES, INC.

7 CLUSTERS COURT, SUITE 201 COLUMBIA, SOUTH CAROLINA 29210 (803) 731-0650 fax (803) 731-2880 EMAIL: KBelka@bellsouth.net

221 PICKENS STREET (29205) POST OFFICE BOX 5875 COLUMBIA, SOUTH CAROLINA 803.834.4048 p 803.834.4082 f WWW.1X1DESIGN.COM

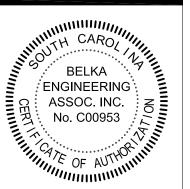

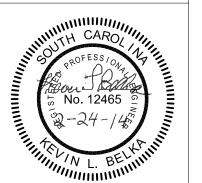

# EXISTING EXIT SIGN, SINGLE OR DOUBLE FACED, CEILING OR WALL MOUNTED

20 AMP DUPLEX RECEPTACLE, FLUSH MOUNTED IN WALL AT 18" AFF (NUMBER DENOTES CIRCUIT)

ELECTRICAL SYMBOL LEGEND

20 AMP DUPLEX RECEPTACLE, FLUSH MOUNTED IN WALL AT 42" AFF OR 6" ABOVE COUNTER BACKSPLASH (GFI = GROUND FAULT INTERRUPTER; WP = WEATHERPROOF METALLIC "IN-USE" TYPE COVER)

20 AMP DOUBLE DUPLEX RECEPTACLE, FLUSH MOUNTED IN WALL AT 18" AFF UNLESS NOTED OTHERWISE.

TELEPOWER POLE - COORDINATE LOCATION WITH FURNITURE AND CEILING EQUIPMENT. PROVIDE CONNECTIONS TO FURNITURE. PROVIDE SEPARATE CHANNELS FOR POWER AND COMMUNICATIONS CONDUCTORS.

DEMOLITION/RENOVATION NOTATION

E EXISTING DEVICE TO REMAIN. FUNCTION SHALL REMAIN AT THIS LOCATION. PROVIDE NEW DEVICES AND WALL

R EXISTING DEVICE TO BE REMOVED BY

RE EXISTING DEVICE TO BE REMOVED BY

ELECTRICAL CONTRACTOR. EXISTING CIRCUIT SHALL BE RETAINED. FOR VOICE/DATA STATIONS, COIL CABLE

BRANCH CIRCUIT.

ELECTRICAL DRAWING INDEX

PARTIAL SIXTH FLOOR POWER DEMOLITION PLAN

PARTIAL SIXTH FLOOR POWER RENOVATION PLAN

PARTIAL SIXTH FLOOR LIGHTING RENOVATION PLAN

 $\bigoplus_{i=1}^R$ 

ELECTRICAL CONTRACTOR. DISPOSE OF REMOVED COMPONENTS. MAINTAIN

CONTINUITY OF REMAINING PORTIONS OF

ABOVÉ CEILING FOR USE IN RENOVATION.

EXISTING LIGHTING FIXTURES

PROVIDE NEW DEVICE AS SHOWN ON

RENOVATION PLANS. SEE SHEET E-2.

VOICE/DATA J-BOX, FLUSH MOUNTED IN WALL AT 18" AFF UNLESS NOTED OTHERWISE. PROVIDE A 4" SQUARE x 2" DEEP STEEL BOX WITH SINGLE-GANG PLASTER RING AND BLANK PLASTIC/PHENOLIC WALLPLATE. PROVIDE ONE 1" EMT RACEWAY WITH PULL STRING FROM BOX TO SPACE ABOVE DROP CEILING. TURN A 90 DEGREE BEND IN RACEWAY ABOVE DROP CEILING AND TURN TOWARD MAIN COMMUNICATION ROOM. PROVIDE A PLASTIC BUSHING ON BOTH ENDS OF


JUNCTION BOX, FLUSH MOUNTED IN WALL AT 18" AFF UNLESS NOTED OTHERWISE (FUNCTION AS INDICATED ON PLAN)

ELECTRICAL PANELBOARDS, SURFACE AND FLUSH MOUNTED RESPECTIVELY

MOUNTING HEIGHTS INDICATED IN THIS LEGEND SHALL BE TO CENTERLINE OF DEVICE BOX. ALL SWITCHES AND PULL STATIONS SHALL BE INSTALLED TO BE 48" AFF TO TOP OF BOX. UNLESS NOTED OTHERWISE.

### GENERAL REQUIREMENTS

- 1. FIELD VERIFY EXISTING CONDITIONS. REPORT DISCREPANCIES TO PROJECT MANAGER PRIOR TO COMMENCEMENT OF WORK. LOCATIONS OF EXISTING POWER AND DATA WERE TAKEN FROM EXISTING DRAWINGS. SOME LOCATIONS ARE BEHIND CABINETS/FURNITURE. LOCATIONS WERE NOT FIELD VERIFIED.
- 2. AT LOCATIONS WHERE POWER OR DATA LINES ARE REMOVED, REMOVE WIRING BACK TO SOURCE - PROVIDE COVER PLATES; NEW COVER PLATE TO MATCH EXISTING ADJACENT OUTLET COVERS (TYPE, SIZE AND COLOR AS CLOSELY AS POSSIBLE).
- 3. PROTECT ALL FIRE ALARMS, STROBES, EXIT LIGHTS AND SMOKE DETECTORS AND SIMILAR EQUIPMENT FROM DUST AND DAMAGE DURING RENOVATIONS.
- 4. RENOVATION SHALL REQUIRE TWO TELEPOWER POLES. CONTRACTOR MAY SELECT ANY OF THE TELEPOWER POLES REMOVED TO USE IN THE RENOVATION.

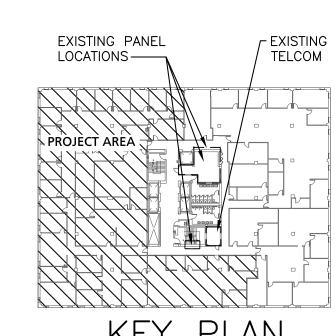

SCALE: NONE


2014 BIDDING

OF


UNIVERSITY


E101 PARTIAL SIXTH FLOOR POWER DEMOLITION PLAN

7 CLUSTERS COURT, SUITE 201 COLUMBIA, SOUTH CAROLINA 29210 (803) 731-0650 fax (803) 731-2880 EMAIL: KBelka@bellsouth.net

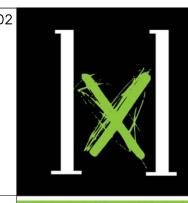

221 PICKENS STREET (29205) POST OFFICE BOX 5875 COLUMBIA, SOUTH CAROLINA 29250 803.834.4048 p 803.834.4082 f WWW.1X1DESIGN.COM

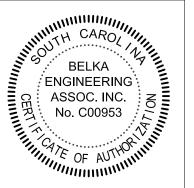

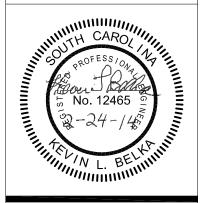


### E EXISTING DEVICE TO REMAIN. FUNCTION

- SHALL REMAIN AT THIS LOCATION. PROVIDE NEW DEVICES AND WALL
- R EXISTING DEVICE TO BE REMOVED BY ELECTRICAL CONTRACTOR. DISPOSE OF REMOVED COMPONENTS. MAINTAIN CONTINUITY OF REMAINING PORTIONS OF BRANCH CIRCUIT.
- RE EXISTING DEVICE TO BE REMOVED BY ELECTRICAL CONTRACTOR. EXISTING CIRCUIT SHALL BE RETAINED. PROVIDE NEW DEVICE AS SHOWN ON RENOVATION

# NOTES


- 1. ALL RECEPTACLES ON THIS SHEET SHALL BE FED FROM EXISTING ELECTRICAL PANELS. CIRCUIT NUMBERS SHOWN ARE FOR DIAGRAMMATIC PURPOSES ONLY AND DO NOT CORRESPOND TO ACTUAL CIRCUIT BREAKER POSITION NUMBERS.
- 2. MANY NEW DUPLEX RECEPTACLES SHALL BE FED USING CIRCUITS THAT PREVIOUSLY FED RECEPTACLES REMOVED IN RENOVATION PHASE.
- 3. THIS CLUSTER OF 2-DUPLEX RECEPTACLES AND 2-VOICE/DATA STATIONS SHALL BE FED FROM EXISTING WIRING PREVIOUSLY ROUTED TO PARTITION FURNITURE VIA TELEPOWER POLE. LOCATE NEW TELCOM STATIONS SO THAT EXISTING CABLING WILL CONNECT.
- 4. THIS CLUSTER OF 1-DUPLEX RECEPTACLE AND 1-VOICE/DATA STATION SHALL BE FED FROM EXISTING WIRING PREVIOUSLY ROUTED TO PARTITION FURNITURE VIA TELEPOWER POLE. LOCATE NEW TELCOM STATIONS SO THAT EXISTING CABLING WILL CONNECT.
- 5. IF EXISTING VOICE/DATA CABLING IS LONG ENOUGH TO REACH NEW LOCATIONS THEN CABLING MAY BE RE-USED. IF NOT, PROVIDE NEW CABLING - COORDINATE WITH NOLAN WESTBURY, USC UTS.
- 6. NEW PARTITIONS SHALL BE FED FROM RELOCATED TELEPOWER POLES, WALL DROPS, OR EXISTING DEVICE BOXES.
- 7. TELEPOWER POLES SHALL BE FED BY LOCAL EXISTING CIRCUITS.

### DEMOLITION/RENOVATION NOTATION

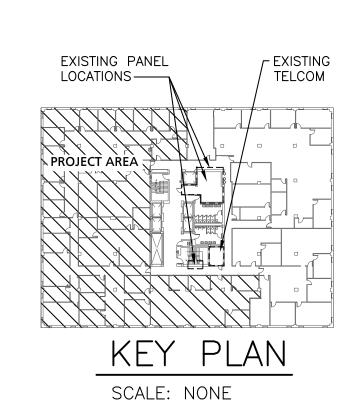

CAROLINA

E102 PARTIAL SIXTH FLOOR POWER RENOVATION PLAN

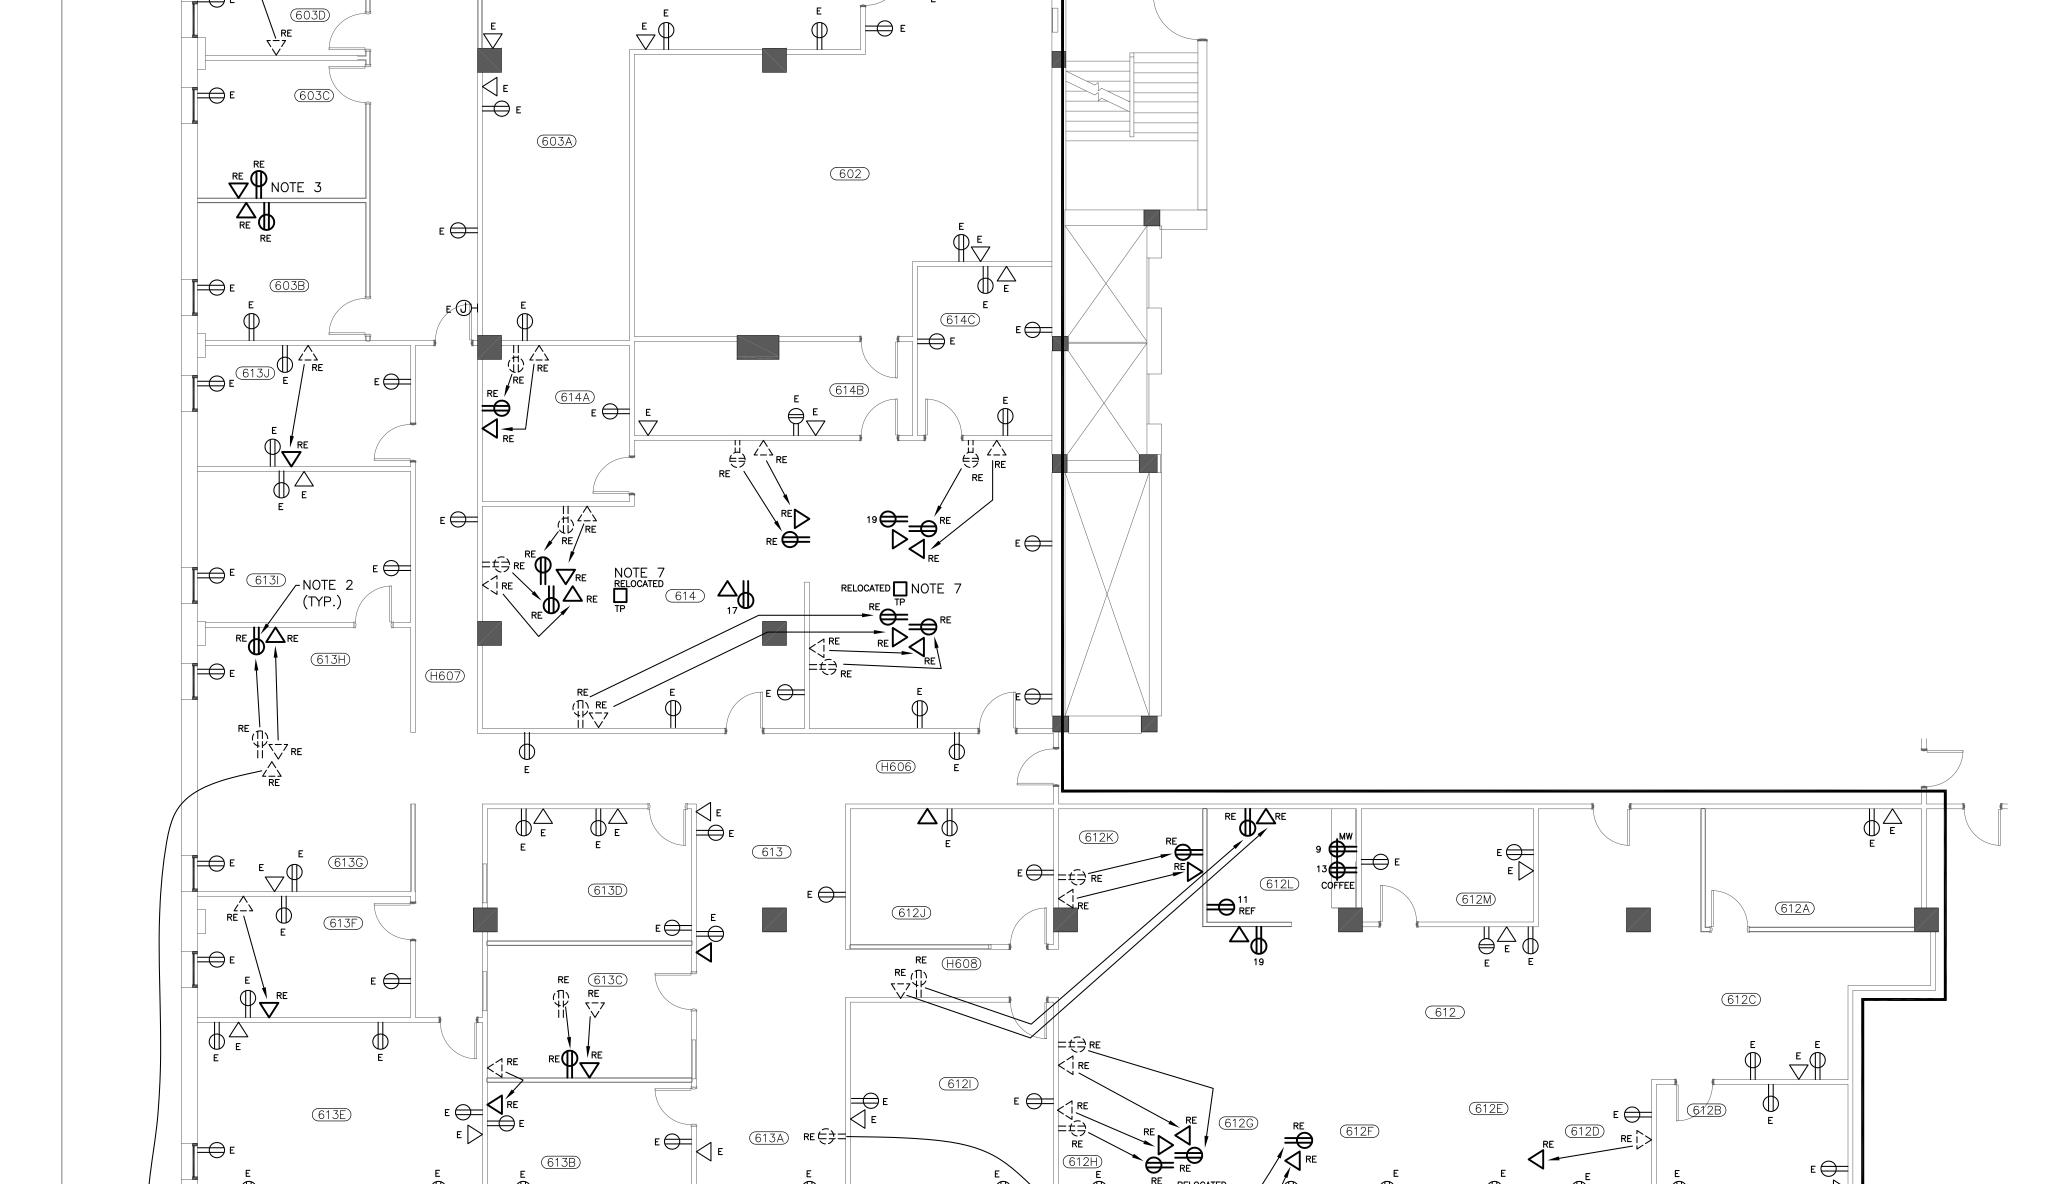

PARTIAL SIXTH FLOOR POWER RENOVATION PLAN

SCALE: 1/8" = 1'-0"

RE ()

E 😂

(603N)

(603G)

RELOCATED

NOTE 3

603

NOTE 3

(603E)

E 603F

Ī₩ E





7 CLUSTERS COURT, SUITE 201 COLUMBIA, SOUTH CAROLINA 29210 (803) 731-0650 fax (803) 731-2880 EMAIL: KBelka@bellsouth.net



### DESIGN

221 PICKENS STREET (29205)
POST OFFICE BOX 5875
COLUMBIA, SOUTH CAROLINA
29250
803.834.4048 p
803.834.4082 f
WWW.1X1DESIGN.COM

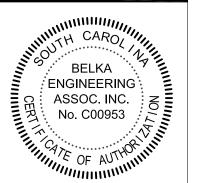

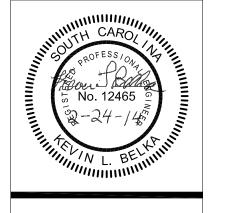

# ELEASED FOR BIDDING-FEBRUARY 24, 2014 REVISIONS NO. Description Date PROJECT NUMBER SHEET NAME PARTIAL SIXTH FLOOR LIGHTING RENOVATION PLAN BROJECT NUMBER PROJECT NUMBER PROJECT NUMBER PARTIAL SIXTH FLOOR LIGHTING RENOVATION PLAN

CAROLINA

UNIVERSITY

### NOTES


- FIXTURES SHOWN CLOUDED ARE EXISTING FIXTURES TO BE RELOCATED. FIXTURES IN BOLD AND DESIGNATED WITH "RE" ARE THE RELOCATED FIXTURES IN THEIR NEW POSITION. FIXTURES CLOUDED AND MARKED "REMOVE" ARE TO BE REMOVED AND TURNED OVER TO OWNER.
- 2. FIXTURES NOT MARKED SHALL BE EXISTING TO REMAIN.
- 3. CLEAN AND RELAMP ALL FIXTURES.
- 4. PROVIDE AN ALLOWANCE IN BID TO CHANGE THE CONNECTION OF A TOTAL OF FIVE EXISTING LIGHTING FIXTURES TO BE NIGHTLIGHTS ON GENERATOR BACKED EXISTING CIRCUIT IN LIEU OF AS SHOWN IF SO REQUIRED BY STATE ENGINEER AT SUBSTANTIAL COMPLETION.
- 5. EXISTING FIRE ALARM SYSTEM FUNCTIONALITY SHALL BE MAINTAINED. WHERE CEILING/STRUCTURE RENOVATIONS ARE DONE WHERE FIRE ALARM SYSTEM COMPONENTS ARE SUPPORTED THOSE COMPONENTS SHALL BE TEMPORARILY SUPPORTED AND SUBSEQUENTLY INSTALLED/MOUNTED ON RENOVATION CEILING/STRUCTURE.

EXISTING PANEL LOCATIONS

KEY PLAN

SCALE: NONE

FEXISTING TELCOM

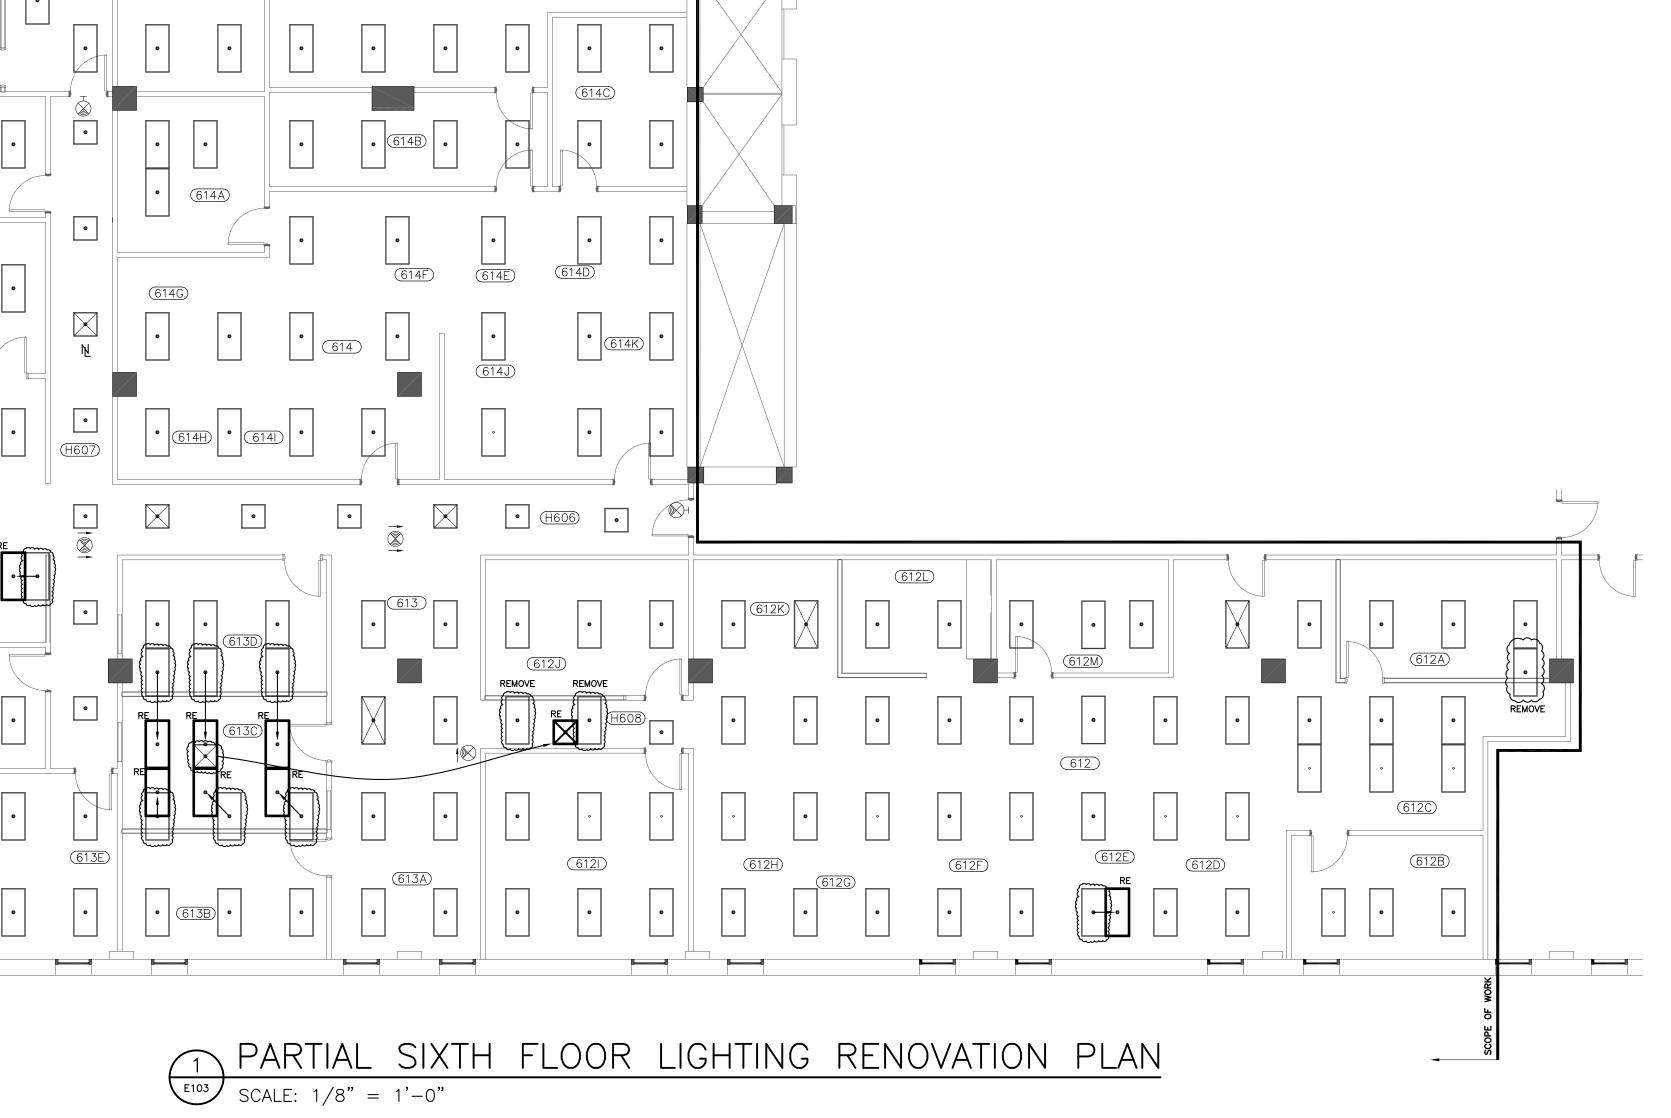

g _______

____

613G